Village of Beecher

625 Dixie Highway PO Box 1154 Beecher, Illinois 60401 Phone: 708-946-2261 Fax: 708-946-3764

www.villageofbeecher.org



President Marcy Meyer Clerk Janett McCawley **Administrator** Charity Mitchell Treasurer Donna Lippelt

Trustees Todd Kraus Ioe Tieri Roger Stacey Erik Gardner David Weissbohn Brian Diachenko

MEETING OF THE BEECHER PLANNING AND ZONING COMMISSION

(THE PZC) Thursday, September 26, 2024 at 7:00 p.m.

Beecher Village Hall 625 Dixie Highway Beecher, Illinois

- I. PLEDGE OF ALLEGIANCE
- II. **ROLL CALL**
- III. CONSIDER APPROVAL OF THE MINUTES OF THE PREVIOUS MEETING
- IV. RECOGNITION OF THE PUBLIC
- V. WORKSHOP: DISCUSSION OF A SPECIAL USE PERMIT REQUEST IN A B-1 HISTORIC DOWNTOWN BUSINESS DISTRICT FOR A TOBACCO AND VAPE SHOP AT 759 W INDIANA AVENUE. The applicant will be present to explain a business plan and answer any questions of the Commission prior to setting the public hearing. Application is enclosed.
- VI. DISCUSSION OF RE-SUBDIVISION OF LOTS 49-51 ON SOMERSET DRIVE IN THE PRAIRIE PARK SUBDIVISION. Developer will be present to explain the request and answer questions of the Commission.
- VII. CONSIDER A RECOMMENDATION TO THE VILLAGE BOARD REGARDING A SPECIAL USE PERMIT APPLICATION TO PERMIT THE CONSTRUCTION OF A COMMUNITY SOLAR GARDEN / COMMERCIAL FACILITY LOCATED ON SOUTH PARK ROAD. THE PROJECT SIZE IS APPROXIMATELY 35.8 ACRES. Since the project is within 1.5 miles of Beecher Village limits, the Village Board can submit a letter of objection or non-objection to be considered by the Will County Land Use Department. The applicant, Wild Cat Solar 4, LLC (New Energy Equity), was unable to attend the meeting on August 22, 2024 when the PZC recommended the Village Board submit a letter of objection. Since this project is still in the application process with Will County Land Use Department, the applicant requested the opportunity to attend this PZC meeting to address any questions or concerns of the PZC. A representative from New Energy Equity will be present answer any questions of the Commission.
- VIII. DISCUSSION OF SURF INTERNET FIBER BUILD. A representative from Surf Internet will be present to answer questions of the Commission.
- IX. **OLD BUSINESS**
 - a. UPDATE ON REVISION OF ZONING ORDINANCE

X.	NEW BUSINESS
XI.	ADJOURNMENT - NEXT MEETING SCHEDULED FOR THURSDAY, OCTOBER 24, 2024 AT 7:00PM.

MINUTES OF THE BEECHER PLANNING AND ZONING COMMISSION

(THE PZC)

Thursday, August 22, 2024 at 7:00 p.m. Beecher Village Hall 625 Dixie Highway

At 7:01 p.m., Chairman George Schuitema called the meeting to order.

All present joined in the pledge to the flag.

ROLL CALL. Members present: Commissioners Eich, Gardner, Heim, Schuitema and Serviss. Member absent: Commissioner Hearn (arrived at 7:08 p.m.).

Staff present: Secretary Patty Meyer, Administrator Charity Mitchell and Pete Iosue of Teska Associates.

Guests: Village President Marcy Meyer and Trustee Erik Gardner.

CONSIDER APPROVAL OF THE MINUTES OF THE JULY 25, 2024 MEETING. Commissioner Heim made a motion to approve the minutes of the July 25, 2024 PZC meeting as written. Commissioner Eich seconded the motion.

AYES: Commissioners Eich, Gardner, Heim, Schuitema and Serviss.

NAYS: None.

ABSENT: Commissioner Hearn.

Motion carried.

RECOGNITION OF THE PUBLIC. None.

CONSIDER A RECOMMENDATION TO THE VILLAGE BOARD REGARDING A SPECIAL USE PERMIT APPLICATION TO PERMIT THE CONSTRUCTION OF A COMMUNITY SOLAR GARDEN/COMMERCIAL FACILITY LOCATED ON SOUTH PARK ROAD. THE PROJECT SIZE IS APPROXIMATELY 35.8 ACRES. Wild Cat Solar 4, LLC (New Energy Equity) has submitted a special use permit application to the Will County Land Use Department. Since the project is within 1.5 miles of Beecher Village limits, the Village Board can submit a letter of objection or non-objection to be considered by the County Board.

Administrator Mitchell provided a copy of Washington Township's letter of objection to Will County regarding the proposed solar garden/commercial facility located on South Park Road.

Petitioner for the project was not present. Pete Iosue suggested that a Village representative could attend Will County's meeting when this project is discussed and express concerns.

Commissioner Gardner expressed concern of the multiple unsightly poles along the roads for the solar projects, because the contractor doesn't want to pay to bury the wires. He expressed concerns of how the farmland would be restored once the life span of a solar project is over.

Commissioner Hearn arrived at 7:08 p.m.

Commissioner Heim expressed concerns about where the lines for this current proposed project would run. He does not support the proposed project.

Commissioner Eich expressed concerns that future homes in Nantucket Cove could be located very close to the proposed project.

Administrator Mitchell reported that the public hearing for this project has not yet been scheduled at Will County.

Commissioner Heim made a motion authorizing Staff to provide a letter of objection to the project. There is no benefit to the Village. Commissioner Gardner seconded the motion.

AYES: Commissioners Eich, Gardner, Hearn, Heim, Schuitema and Serviss.

NAYS: None.

Motion carried.

REVIEW AND DISCUSS DRAFT OF AMENDED ZONING ORDINANCE.

Pete Iosue is looking for feedback on the provided draft. PZC members were asked to have their comments marked on their draft ordinance for the September 26th meeting, and discussion will occur at that meeting.

Pete Iosue mentioned that he spoke with Administrator Mitchell about lot coverage, accessory uses and other commonly asked questions regarding Building Department matters. Simple and easily understood handouts for residents would be helpful.

OLD BUSINESS- None.

NEW BUSINESS.

Commissioner Schuitema asked President Meyer if there was any update on filling the Commissioner vacancy. She stated that position should be filled by next meeting.

Updates were provided on the new Police Department, Domino's, the craft grow facility on Church Road, the restaurant proposed for former gun shop, Elsie's Place, new ownership at The Gould Vault and the burnout event to be held on August 24th.

Questions were asked about the status of the vacant building on Gould Street. There was nothing new to report.

The next regularly scheduled meeting for the PZC is Thursday, September 26, 2024 at 7:00 p.m.

ADJOURNMENT. Commissioner Serviss made a motion to adjourn the meeting. Commissioner Eich seconded the motion.

AYES: Commissioners Eich, Gardner, Hearn, Heim, Schuitema and Serviss.

NAYS: None. Motion carried.

Meeting adjourned at 7:32 p.m.

Respectfully submitted,

Patty Meyer Secretary

Village of Beecher

625 Dixie Highway PO Box 1154 Beecher, Illinois 60401 Phone: 708-946-2261

Fax: 708-946-3764 www.villageofbeecher.org

Date:



President
Marcy Meyer
Clerk
Janett McCawley
Administrator
Charity Mitchell
Treasurer
Donna Rooney

Trustees
Todd Kraus
Joe Tieri
Roger Stacey
Joseph Gianotti
Erik Gardner
David Weissbohn

APPLICATION FOR A SPECIAL USE PERMIT

Name: Vic REATO
Address: 759 W. Inniana Av. Britishen, D. 60401
Phone Number:
Address of Location Where Special Use Permit is being Requested if Different from Abov
Type of Special Use Permit being Requested: VAR Shaf
Section of the Zoning Code Pertaining to this Special Use Permit: HISTORIC POWNTOWN DISTRICT
Why Are You Requesting this Special Use Permit?: Per Village

A plat of survey of the property which includes the legal description.
A diagram showing the exact location of any improvement to the property which is the subject of this special use permit request.
A photograph or photographs of the property where the special use permit is being requested.
Exact drawings of the improvements being proposed (blueprint, pictures of the improvement from a brochure, sketches.)
non-refundable fee of \$750.00 to the Village of Beecher to pay for legal notices, letters of notification, recording secretary, and staff support.
I hereby attest that the contents of this application is complete and true in fact.
SIGNED: Vital , Petitioner Date: 8.27.24
(For office use only)
Date set for presentation to the Village Board:
Date set for PZC Workshop: 900000000000000000000000000000000000
Date set for Public Hearing:

The following needs to accompany this application:

shared:Word:Special Use Permit Application


















DAVID A. RING & ASSOCIATES REGISTERED LAND SURVEYORS


17853 DIXIE HIGHWAY HOMEWOOD, ILLINOIS 60430

S.E. CORNER DIXIE HWY & PINE ROAD

PLAT OF SURVEY

OF REED STREET AS LOCATED BETWEEN THE EAST LINE OF CHICAGO AND EASTERN ILLINOIS RAILROAD RIGHT OF WAY AND THE WEST LINE OF BLOCK 12 IN THE VILLAGE OF BEECHER, IN THE SOUTHWEST 1/4 OF SECTION 16, TOWNSHIP 33 NORTH, RANGE 14 EAST OF THE THIRD PRINCIPAL MERIDIAN, IN WILL COUNTY, ILLINOIS

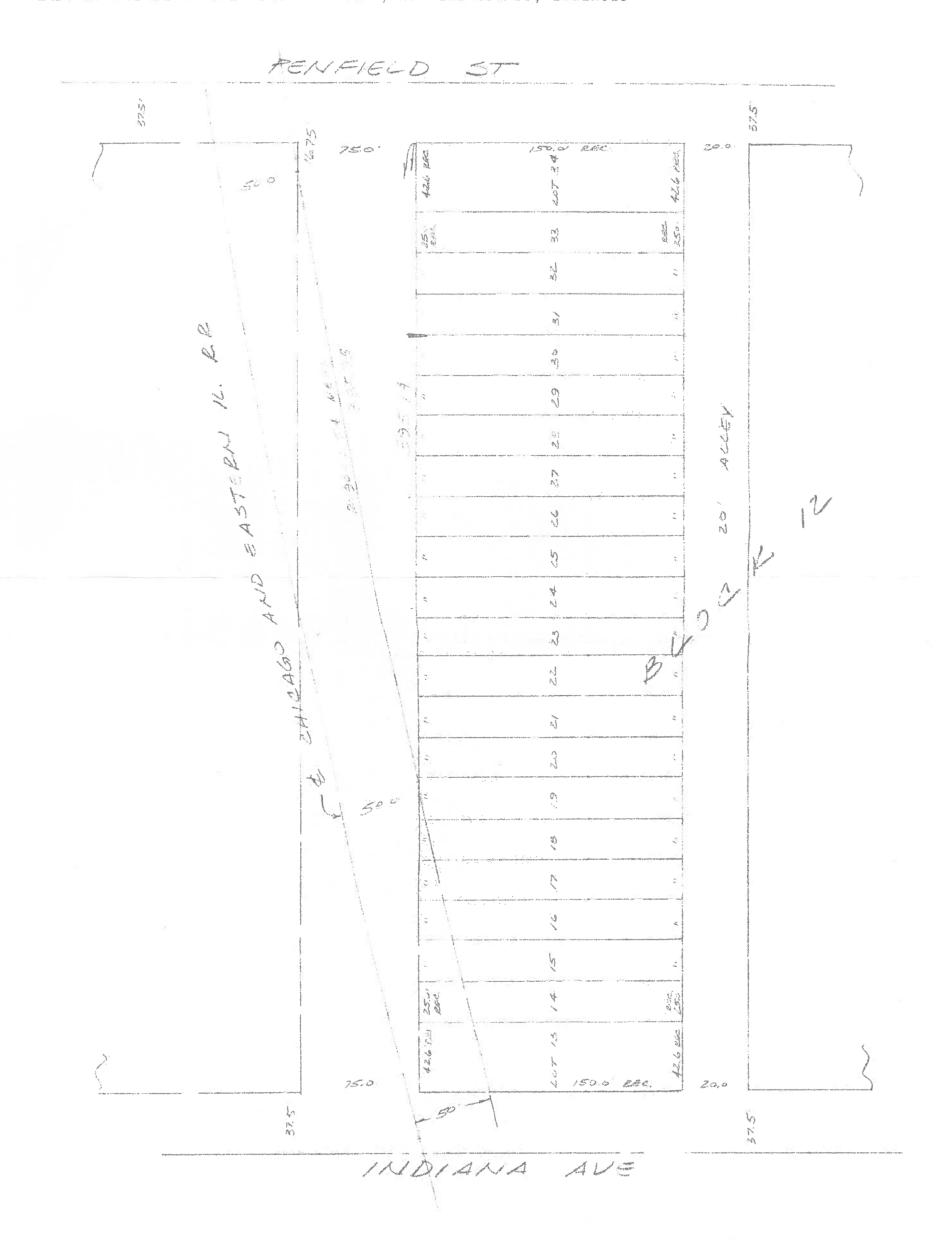


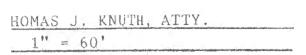

9606126





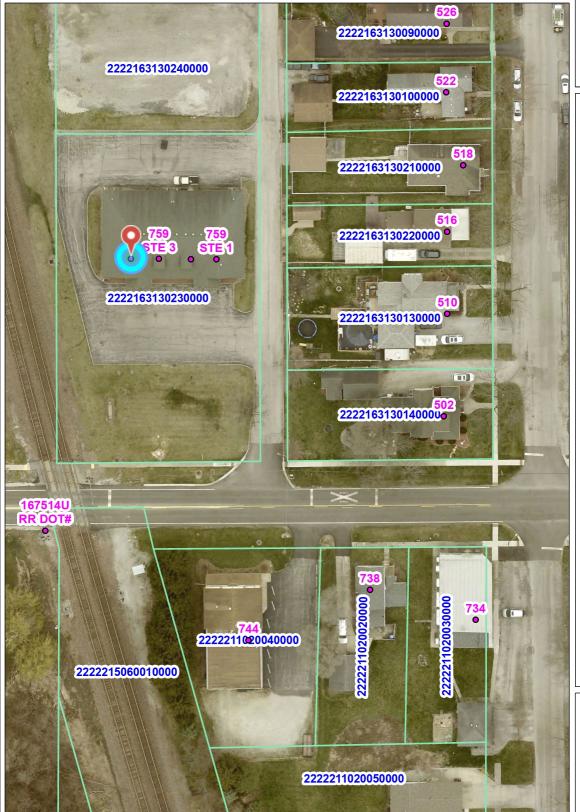




Legend

- Address Points
- Parcels
 - Townships

Notes

Date: 9/24/2024

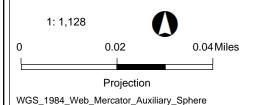

Disclaimer of Warranties and Accuracy of Data: Although the data developed by Will County for its maps, websites, and Geographic Information System has been produced and processed from sources believed to be reliable, no warranty, expressed or implied, is made regarding accuracy, adequacy, completeness, legality, reliability or usefulness of any information. This disclaimer applies to both isolated and aggregate uses of the information. The County and elected officials provide this information on an "as is" basis. All warranties of any kind, express or implied, including but not limited to the implied warranties of merchantability, fitness for a particular purpose, freedom from contamination by computer viruses or hackers and non-infringement of proprietary rights are disclaimed. Changes may be periodically made to the information herein; these changes may or may not be incorporated in any new version of the publication. If you have obtained information from any of the County web pages from a source other than the County pages, be aware that electronic data can be altered subsequent to original distribution. Data can also quickly become out of date. It is recommended that careful attention be paid to the contents of any data, and that the originator of the data or information be contacted with any questions regarding appropriate use. Please direct any questions or issues via email to gis@willcountyillinois.com.

PRAIRIE PARK RE-SUBDIVISION PHASE II SETBACK AND TYPICAL EASEMENTS EXHIBIT PUBLIC GRAPHIC SCALE (IN FEET) 1 inch = 100 ft. SURVEYOR'S CERTIFICATE: C16 49.47 33.000' N0530755"W 49.42' 833519' C17 12.97' 270.000' N0520755"W 49.42' 270.00' N0520756"W 12.97' 274512' C18 8.27' 270.00' N324426"W 8.27' 14519' C19 112.62' 270.00' N19754'50"W 111.80' 23'53'52' C19 112.62' 270.00' N19754'50"W 111.80' 2755' C19 112.62' 270.00' N19754'50"W 111.80' 2755' C19 112.62' 2750' C19 112.62' C STATE OF ILLINOIS) COUNTY OF WILL) THIS IS TO CERTIFY THAT I, MATTHEW D. DUNN, ILLINOIS REGISTERED LAND SURVEYOR NO. 3107, I HAVE SURVEYED AND SUBDIVIDED THE FOLLOWING PROPERTY AS DIRECTED BY THE OWNER: LOTS 49 THRU 51 IN PRAIRIE PARK, A SUBDIMSION OF PART OF THE SOUTHEAST QUARTER OF SECTION 9, TOWNSHIP 33 NORTH, RANGE 14 EAST OF THE THIRD PRINCIPAL MERIDIAN, RECORDED DECEMBER 13, 2005 AS DOCUMENT NO. R2005-218550, IN WILL COUNTY, LILINOIS. LOTS 1 THRU 54 ARE ALL PARTS OF THE EXISTING PRAIRIE PARK SUBDIVISION RECORDED 12-13-2005 AS DOCUMENT NO. R2005-218550. REFERE TO THAT PLAT AND ANY CERTIFICATES OF CORRECTION TO THAT SAME PLAT FOR RECORD DATA OF THOSE LOTS. 2. FRONT BUILDING SETBACK FOR ALL RESIDENTIAL LOTS ON THIS PLAT (LOTS 94-99) SHALL BE 25 FEET. 3. 5 FOOT PUBLIC UTILITY & DRAINAGE EASEMENTS ARE HEREBY DEDICATED ALONG THE SIDE YARD LINES AND 10 FOOT PUBLIC UTILITY AND DRAINAGE EASEMENTS ARE HEREBY DEDICATED ALONG THE REAR YARD LINES OF AIL LOTS IN THIS PLAT UNIESS DEPICTED IN ANOTHER MANDR. . ALL ROADWAYS SHOWN INCLUDING WATERFORD LANE, PRAIRIE PARK (ASHFORD) BOULDEVARD, CLIFTON AVENUE AND SOMERSET DRIVE WERE PERVIOUSLY DEDICATED IN THE ORIGINAL PLAT OF PRAIRIE PARK MENTIONED ABOVE. SAND DEDICATED STREETS REMAIN AS DEDICATED ON SAID PLAT AND SUBSEQUENT CERTIFICATES OF CORRECTION. 5. LOT 94 ON THIS PLAT IS (LOT 71 ON THE ORIGINAL PLAT OF PRAIRIE PARK RECORDED 12-13-2005 AS DOCUMENT NO. R2005-218550) PARTLY LIES WITHIN ZONE A, A SPECIAL FLOOD HAZARD AREA PER FLOOD INSURANCE RATE MAP PANEL NUMBER 17197C00326E WITH AN EFFECTIVE DATE OF SEPTEMBER 6, 1995 AS PUBLISHED BY ITH FEDERAL MERGENCY MANAGEMENT AGENCY. 6. THE SUBDIVISION IS WITHIN THE LIMITS OF THE VILLAGE OF BEECHER. 7. ALL THE LOT CORNERS AND POINTS OF CURVATURE HAVE BEEN MONUMENTED WITH 1/2" REBAR. B. ALL DISTANCES ARE SHOWN IN FEET AND DECIMAL PARTS THEREOF. 9. THE ATTACHED PLAT IS A CORRECT REPRESENTATION OF SAID SURVEY AND SUBDIVISION. 10. THE SUBDIVISION PARCELS CONTAINS 40781 SQ.FT. OR 0.94 ACRES MORE OR LESS. 11. P.U.&D.E. = PUBLIC UTILITY AND DRAINAGE EASEMENT DATED THIS _____ DAY OF ____ MATTHEW D. DUNN, ILLINOIS PROFESSIONAL SURVEYOR NO. 3107 OWNER'S AND ENGINEER'S SURFACE WATER DRAINAGE STATEMENT: I HEREBY DECLARE THAT TO THE BEST OF OUR KNOWLEDGE AND BELIEF, THE DRAINAGE OF SURFACE WATERS ON THE STE DEPICTED BY THIS PLAT WILL NOT BE CHANGED BY CONSTRUCTION OF IMPROVEMENTS WATERS ON THE STEED STEED BY THIS PLAT WILL NOT BE CHANGED BY CONSTRUCTION OF MERCENT WATERS INTO PROMISONS WERE PREVIOUSLY WADE FOR COLLECTION AND UNFERSION OF SUCH SIZEACE WATERS INTO PUBLIC AREAS, OR DRAINS WHICH THE DEVELOPER HAS THE RIGHT TO USE, AND THAT SUCH SURFACE WATERS WERE PREVIOUSLY PLANEEFOR IN ACCORDANCE WITH CENTRALLY ACCEPTED ENGINEERING PRACTICES WITH THE DEVELOPMENT OF THE ORIGINAL PRAINE PARK SUBDIVISION AND TO REDUCE THE LUNCLYHOOD OF DAMAGE TO ADJOINNE PROPERTIES DUE TO CONSTRUCTION OF THIS DEVELOPMENT. OWNER OR ATTORNEY IN FACT ENGINEER: MATTHEW D. DUNN ILLINOIS P.E. # 35-047326 COUNTY OF WILL) SCHOOL DISTRICT DECLARATION: THE OWNER UNDERSTANDS AND CERTIFIES THAT THE PROPERTY DEPICTED IN THIS PLAT LIES WITHIN THE FOLLOWING SCHOOL DISTRICTS: ELEMENTARY SCHOOL DISTRICT: 200U, BEECHER ELEMENTARY HIGH SCHOOL DISTRICT: 200U, BEECHER HIGH SCHOOL COMMUNITY COLLEGE DISTRICT: 515, PRAIRIE STATE COMMUNITY COLLEGE __ DAY OF ____ ADDRESS NOTARY PUBLIC CERTIFICATE: STATE OF ILLINOIS)
()SS HERBY CERTIFY THAT IS SUBSCRIBED TO THE FORGOING CERTIFICATE, APPEARED BEFORE ME THIS DAY IN PERSON AND COKNOMEDGED THE EXECUTION OF THE AMERIED PLAT AND ACCOMPANYING INSTRUMENTS FOR THE USES AND PURPOSES THEREIN SET FORTH AS HIS FREE AND VOLUNTARY ACT. GIVEN UNDER MY HAND AND SEAL THIS ____ __ DAY OF ____ NOTARY PUBLIC: RECORDER'S CERTIFICATE: COUNTY OF WILL) THIS INSTRUMENT NO: ___ WAS FILED FOR RECORD IN THE RECORDER'S OFFICE OF WILL COUNTY AFORESAID ON THIS _____ DAY OF _____ AND RECORDED IN BOOK OF PLATS ON PAGE COUNTY CLERK'S CERTIFICATE: THIS IS TO CERTIFY THAT I FIND NO DELINQUENT OR UNPAID CURRENT TAXES AGAINST ANY OF THE REAL ESTATE DESCRIBED IN THE FOREGOING CERTIFICATES. DATED THIS _____ DAY OF _____ A.D. 2024 TAX MAPPING CERTIFICATE: STATE OF ILLINOIS) COUNTY OF WILL) I,
DIRECTOR OF THE TAX MAPPING AND PLATTING OFFICE DO HEREBY CERTIFY
THAT I HAVE CHECKED THE PROPERTY DESCRIPTION ON THIS PLAT AGAINSTA AVAILABLE COUNTY RECORDS
AND FIND SAID DESCRIPTION TO BE TIME AND CORRECT. THE PROPERTY HERBIN DESCRIBED IS LOCATED ON
TAX MAP #22-090-W AND IDENTIFIED AS PERMANENT REAL ESTATE TAX INDEX NUMBERS (PIN)S: $22 - 22 - 09 - 417 - 007 - 0000 \qquad \qquad 22 - 22 - 09 - 417 - 008 - 0000 \qquad \qquad 22 - 22 - 09 - 417 - 009 - 0000$

DATED THIS _____ DAY OF ____

BEECHER PLAN COMMISSION: STATE OF ILLINOIS)

DIRECTOR

CHAIRPERSON:

A.D. 2024

PPROVED BY THE BEECHER PLAN COMMISSION THIS _____ DAY OF ___

DETENTION EASEMENT (DETENTION EASEMENT (DETENT	18	= T=
26 25 UNSUBDIVIDED 18 9 10 10 10 10 10 10 10 10 10 10 10 10 10	18	. 1
No.	17	-
## 1		+
29 30 30 30 30 30 30 30 30 30 30 30 30 30	15	- 5
## DETENTION Same of the weight A st A of sec. 4-33-14 Same of the sec. 4 A st A of sec. 4-33-14 Same of the sec. 4 A st A of sec. 4-33-14 Same of the sec. 4 A st A of sec. 4-33-14 Same of the sec. 4 A st A of sec. 4-33-14 Same of the sec. 4 A st A of sec. 4-33-14 Same of the sec. 4 A st A of sec. 4-33-14 Same of the sec. 4 A st A of sec. 4-33-14 Same of the sec. 4 A st A of sec. 4-33-14 Same of the sec. 4 A st A of sec. 4-33-14 Same of the sec. 4 A of sec. 4-33-14 Same of the sec. 4 A of sec. 4-33-14 Same of the sec. 4 A of sec. 4-33-14 Same of the sec. 4 A of sec. 4-33-14 Same of the sec. 4 A of sec		
DETENTION NOOST TO SEE AND I/A, SE I/A OF SEE A-33-14 NOOST TO SEE AND I/A, SE I/A OF SEE A-33-14 NOOST TO SEE AND I/A, SE I/A OF SEE A-33-14 DETENTION EASEMENT ORDER FOR THE SEE I/A, SE I/A OF SEE A-33-14 DETENTION EASEMENT ORDER FOR THE SEE AND I/A, SE I/A OF SEE A-33-14 DETENTION EASEMENT ORDER FOR THE SEE AND I/A, SE I/A OF SEE A-33-14 DETENTION EASEMENT ORDER FOR THE SEE AND I/A SE I/A OF SEE A-33-14 DETENTION EASEMENT ORDER FOR THE SEE AND I/A SE I/A OF SEE A-33-14 DETENTION EASEMENT ORDER FOR THE SEE AND I/A SE I/A OF SEE A-33-14 DETENTION EASEMENT ORDER FOR THE SEE AND I/A SE I/A OF SEE A-33-14 DETENTION EASEMENT ORDER FOR THE SEE AND I/A SE I/A OF SEE A-33-14 DETENTION EASEMENT ORDER FOR THE SEE AND I/A SE I/A OF SEE A-33-14 DETENTION EASEMENT ORDER FOR THE SEE AND I/A SE I/A OF SEE A-33-14 DETENTION EASEMENT ORDER FOR THE SEE AND I/A SE I/A OF SEE A-33-14 DETENTION EASEMENT ORDER FOR THE SEE AND I/A SE I/A OF SEE A-33-14 DETENTION EASEMENT ORDER FOR THE SEE AND I/A SE I/A OF SEE A-33-14 DETENTION EASEMENT ORDER FOR THE SEE AND I/A SE I/A OF SEE A-33-14 DETENTION EASEMENT ORDER FOR THE SEE AND I/A SE I/A OF SEE A-33-14 DETENTION EASEMENT ORDER FOR THE SEE AND I/A SE I/A OF SEE A-33-14 DETENTION EASEMENT ORDER FOR THE SEE AND I/A SEE A-33-14 DETENTION EASEMENT ORDER FOR THE SEE AND I/A SEE A-33-14 DETENTION EASEMENT ORDER FOR THE SEE AND I/A SEE A-33-14 DETENTION EASEMENT ORDER FOR THE SEE AND I/A SEE AND I/	13	'
NSO THE NO THE N	12	\neq
NBSS7735"E 10.00" NBSS7735"E 10.00" NBSS7735"E 10.00" NBSS874		~
UNSUBDIVIDED UNSUBDIVIDED UNSUBDIVIDED UNSUBDIVIDED OR A STATE OF THE STATE OF		+
DETENTION ESCAPENT (DETENTION ESCAPENT) (DETENTION ESCAPENT) DETENTION ESCAPENT (DETENTION ESCAPENT) (DETE	STING LOT 8 ARKSITE	/
0 0 0 0 0 0 0 0 0 0 0 0 0 0 0 0 0 0 0	1	
39 1 1 1 1 1 1 1 1 1 1 1 1 1 1 1 1 1 1 1	2	l
90 00 00 00 00 00 00 00 00 00 00 00 00 0	app 5	/
		7
\$ \\ \frac{1}{8} \\ \text{history} \\ \\ \\ \\ \\ \\ \\ \\ \\ \\ \\ \\ \\		==-
	99	
29	PARIE PARI	
29 50 Serior Seri		1
UNSUBDIVIDED UNSUBDIVIDED UNSUBDIVIDED UNSUBDIVIDED	- 18 1	1 E.
	80 2 R	BUY S
2883510"W 15 PABLE UTLITY & GRUNN 1971.80"	X (AMENDAL)	-60,00'-
UNSUBDIVIDED	2,8	
SLIME, SE 1/4, SEC 9-33-14	233.00	

APPROVED BY THE VILLAGE BOARD OF THE VILLAGE OF BEECHER, WILL COUNTY, ILLINOIS DATED AT ___ ILLINOIS, THIS _____ DAY OF ___ __ A.D. 2024

EASEMENT PROVISIONS:

EASEMENTS FOR SERVING THE SUBDIVISION AND OTHER PROPERTY WITH ELECTRIC AND COMMUNICATIONS SERVICE IS HEREBY RESERVED FOR AND GRANTED TO:

EXELON CORPORATION (COMMONWEALTH EDISON), NICOR GAS CORPORATION

AMERITECH CORPORATION (AT&T) OR THE VILLAGE OF BEECHER DESIGNATED COMMUNICATIONS AND DATA TRANSMISSIONS SUPPLIER

COMMUNICATIONS AND DATA TRANSMISSIONS SUPPLIER

FIRER RESPECTIVE SUCCESSORS OR ASSIGNS, JOINTY AND SEVERALLY. TO INSTALL, OPERATE, MAINTAIN AND REMOVE, FROM TIME TO TIME, FACULITIES USED IN CONNECTION WITH OVERHEAD, AND UNDERGROUND TRANSMISSION AND PROPERTY OF THE SUPPLIES OF THE FROMERTY SHOWN WITHIN THE DASHED LINES ON THE ATTACHED PLAT OR IN AREAS DESCRIBED OR EPICHED AS PUBLIC UTILITY ASSEMENTS, (PULL OR PLAMED.), (PLEAS REFERRE TO RECORD PLAT OF PRABILE PARK SUBDIVISION FOR FURTHER GRANT OF EASSIVENT IN PREVIOUSLY DEDICATED PUBLIC ROAD RIGHT-OF-WAYS) TOOCTHER WITH THE RIGHT TO INSTALL REQUIRED SERVICE CONNECTIONS OWER OF UNDER THE SURFACE OF EACH LOT AND COMMON AREA OR AREAS TO SERVE IMPROVEMENTS THERON OR ON ADJACENT LOTS THE RIGHT TO CUT, TRIM OR REMOVE TREES, BUSHESS AND ROOTS AS MAY BE REASONABLY REQUIRED INCIDIOTY TO THE RIGHT TO CUT, TRIM OR REMOVE TREES, BUSHESS AND ROOTS AS MAY BE REASONABLY REQUIRED INCIDENT TO THE RIGHT TO CUT, TRIM OR REMOVE TREES, BUSHESS AND ROOTS AS MAY BE REASONABLY REQUIRED INCIDENT TO THE RIGHTS HEREIN CIVEN AND THE RIGHT TO ROTH SHALL NOT BE PLACED OVER GRANTEES. FER FAQUINES OR IN, UPON OR OVER THE PROPERTY WHITH THE ADSHED LAND WASHED LINES AND READ AND RESPONSED TO THE PROPERTY WHITH THE ADSHED LINES AND READ AND RESPONSED AND GRANTED. A FER TRISTALLATION OF ANY SUCH THE PROPERTY WHITH THE ADSHED LINES AND READ AND THE PROPERTY SHALL NOT BE ALTERED IN A MAINTENANCE THEREOF.

AN EASEMENT FOR SERVING THE SUBDIVISION AND OTHER PROPERTY WITH CABLE TELEVISION AND OTHER COMMUNICATIONS (INTERNET) SERVICE IS HEREBY GRANTED TO MERITECH (AT&T) OR THE VILLAGE OF BEECHER DESIGNATED PROVIDER OF SAID SERVICES, THEIR SUCCESSION AND ASSIGNES, TO INSTALL, OPERATE MAINTAIN AND STREAM OF THE VILLAGE OF BEECHER SUBJECT OF THE VILLAGE OF TH

EASEMENT AREA WITHOUT THE PRIOR WRITTEN CONSENT OF THE GRANTE.

AN EASEMENT IS HARREN GRANTED TO NICOR GAS COMPANY, IT'S SUCCESSORS AND ASSIGNS ("MICOR") TO INSTALL.

OPERATE, MAINTAIN, REPAIR AND REMOVE FACULITES USED IN CONNECTION WITH THE TRANSMISSION AND DISTRIBUTION
OF NATURAL GAS IN, OVER, ON, UNDER, ACROSS, ALONG AND DUPON THE SUBFACE OF THE PROPERTY SHOWN OF
DESCRIBED ON THIS PLAT AS A UTILITY EASEMENT (AGAIN, PLEASE REFERE TO RECORD PLAT OF FRAIRE PARK
SUBDIVISION FOR FURTHER GRANT OF EASEMENT IN PREVIOUSLY DEDICATED PUBLIC ROAD RIGHT-OF-WAYS) TOGETHER
WITH THE RIGHT TO INSTALL REQUIRED SERVING CONNECTIONS OVER OR UNDER THE SUBFACE OF EACH LOT TO SERVE
WITH THE RIGHT TO INSTALL REQUIRED SERVING CONNECTIONS OVER OR UNDER THE SUBFACE OF EACH LOT TO SERVE
WITH THE RIGHT TO INSTALL REQUIRED SERVING CONNECTIONS OVER OR UNDER THE SUBFACE OF EACH LOT TO SERVE
WITH THE RIGHT TO INSTALL REQUIRED SERVING CONNECTIONS OVER OR UNDER THE SUBFACE OF EACH LOT TO SERVE
WITH THE RIGHT TO INSTALL REQUIRED SERVING CONNECTIONS OVER OR UNDER THE SUBFACE. OF EACH LOT TO SERVE
WITH THE RIGHT TO INDICATE THE RIGHT TO READ THE PROPERTY OF THE PROPER

ALL EASEMENTS DESCRIBED OR DEPICTED AS PUBLIC UTILITY AND/OR DRAINAGE EASEMENTS (P.U.AD.E. OR P.U.E.) ON THIS PLAT ARE HERBEY GRANTED TO THE WILLAGE OF BEECHER FOR THE PURPOSE OF MAINTENANCE REPAIR AND PERIODIC REFLOCKMENT AS DEEDED OF WILLAGE PUBLIC UTILITIES AND FOR THE WILLAGE TO INSURE THAT SUFFACE OFFICE OF THE PUBLIC DEPICE OF THE WILLAGE THOSE OFFICE OF THE WILLAGE THOSE OFFICE OFFICE OF THE WILLAGE THOSE OFFICE OFFICE

HOMEOWNERS ASSOCIATION DETENTION AREA AND VILLAGE DETENTION EASEMENT:

THE LOT 94 DETENTION EASEMENTS WERE CREATED WITH THE DEVELOPMENT OF THIS PROPERTY TO PROTECT THIS DEVELOPMENT AND SURROUNDING AREAS FROM DAMAGE AS A RESULT OF EXCESS RAINFALL IN THE AREA. THE EASEMENTS AS ANOMY ON LOT 94 ARE PREVIOUSLY AND HERETOFORE RESERVED FOR AND GRANTED TO THE WILLAGE OF BEECHER, THEIR SUCCESSORS AND ASSIGNS.

THE LOT 94 AREA SHALL BE DEEDED 10 THE HOMEOWHERS ASSOCIATION THAT RESULTS FROM THIS DEVELOPMENT ONCE SAID ASSOCIATION IS CREATED. LAWN CARE AND PROPER CRADE MAINTENANCE OF ALL POINDS IN THIS DETENTION AREA SHALL BE THE RESPONSIBILITY OF SAID MOMEOWNERS ASSOCIATION. NO BUILDINGS SHALL BE PLACED ON SAID LOT 94 BUT THE SAME MAY BE USED FOR OTHER PURPOSES THAT DO NOT ADVERSELY EFFECT THE STORPACE/FREE FLOW OF STORMWATER. SAID ASSOCIATION SHALL BE RESPONSIBLE FOR MAINTAINING THE DETENTION AREA AND THE ASSOCIATION OR IT'S MEMBERS MAY NOT DESTROY OR MODIFY THE GRADES OR SLOPES MITHOUT HAVING FIRST RECEIVED PRIOR WRITTEN APPROVAL OF THE TOWNSHIP OF MASHINGTON / THE COUNTY OF MILL, OR ANY OTHER UNIT OF GOVERNMENT HAVING JURISDICTION OVER DRAINING.

IN THE EVENT THAT THE SAID ASSOCIATION OR IT'S MEMBERS FAILS TO PROPERLY MAINTAIN THE WATER DETENTION AREA/EASEMENT, THE VILLAGE OF BECAMER OR ANY OTHER UNIT OF GOVERNMENT HAVING JURISDICTION OVER DRAINAGE, SHALL UPON TEN (10) DAYS PRIOR WRITTEN NOTICE, RESERVE THE RIGHT TO PERFORM, OR HAVE PERFORMED ON IT'S BEHALF, ANY MAINTENANCE WORK TO OR JUPON THE WATER DETENTION AREA/EASEMENT OR THE DETENTION OF ASSAURT ANY MAINTENANCE WORK TO OR JUPON THE WATER DETENTION AREA/EASEMENTOUGH THE DETENTION ASSAURT AREA.

IN THE EVENT THE VILLAGE OF BEECHER OR ANY OTHER UNIT OF LOCAL COVERNMENT HAVING JURISDICTION OVER DRAIMAGE, SHALL BE REQUIRED TO PERFORM, OR HAVE PERFORMED ON IT'S BEHALF, ANY MAINTENANCE WORK TO OW UPON THE WARRE DETENTION AREA EASSEMENT, THE COST TOCOTHER WITH AN ADDITIONAL SUM OF TEN PERCENT (10 %) OF THE COST OF COMPLETION OF THE WORK CONSTITUTES A LEIN AGAINST THE SAID HOMEOWNERS ASSOCIATION OR AGAINST ALL THE HOMEOWNERS IN AS DEPICTED IN THIS DEVELOPMENT AS SAID VILLAGE OR UNIT SESS TIL IN ORDER COLLECT. THE LEIN MAY BE FORECLOSED BY ANY ACTION BROUGHT BY OF ON BEHALF OF THE VILLAGE OR OTHER UNIT OF COVERNMENT.

LINCOLNWAY ENGINEERING AND LAND SURVEYING LTD.

LAND SURVEYING PLANNING ENGINEERING PERMITS LAND DEVELOPMENT SCIENCES AND CONSULTING 846 REGENT STREET, NEW LENOX, IL. 60451 PHONE (630)301-1325

PRAIRIE PARK TOWNHOME ASSOCIATION

P.O. Box 522, Beecher, IL 60401

September 13, 2024

Ms. Charity Mitchell Village Administrator cmitchell@villageofbeecher.org

Dear Ms. Mitchell,

It has come to the attention of the Prairie Park Townhome Association Board (HOA) that there may be a desire from the Developer, Castletown Homes, to build single family homes on lots within the jurisdiction of the HOA. These lots are located on the west side of Somerset Drive immediately south of Ashford Blvd in the Prairie Park Subdivision and they are currently designated and/or zoned for townhome structures (lots 49, 50 and 51).

It is worth noting that this has only come to the HOA's attention through general word of mouth/hearsay. The HOA is unaware of any formal request from the Developer to change the status of these lots. Nevertheless, please be advised that the HOA is not in agreement with any such change at this time.


Should you have any questions or require any additional information, please feel free to contact Peggy Boccia at

In the interim, we thank you for your time and attention to this matter.

Sincerely,


Steve Napierkowski	Nancy Boley	Peggy Boccia
Steve Napierkowski	Nancy Boley	Peggy Boccia
President	Secretary	Treasurer

SICILIANO COMMUNITY SOLAR GARDEN

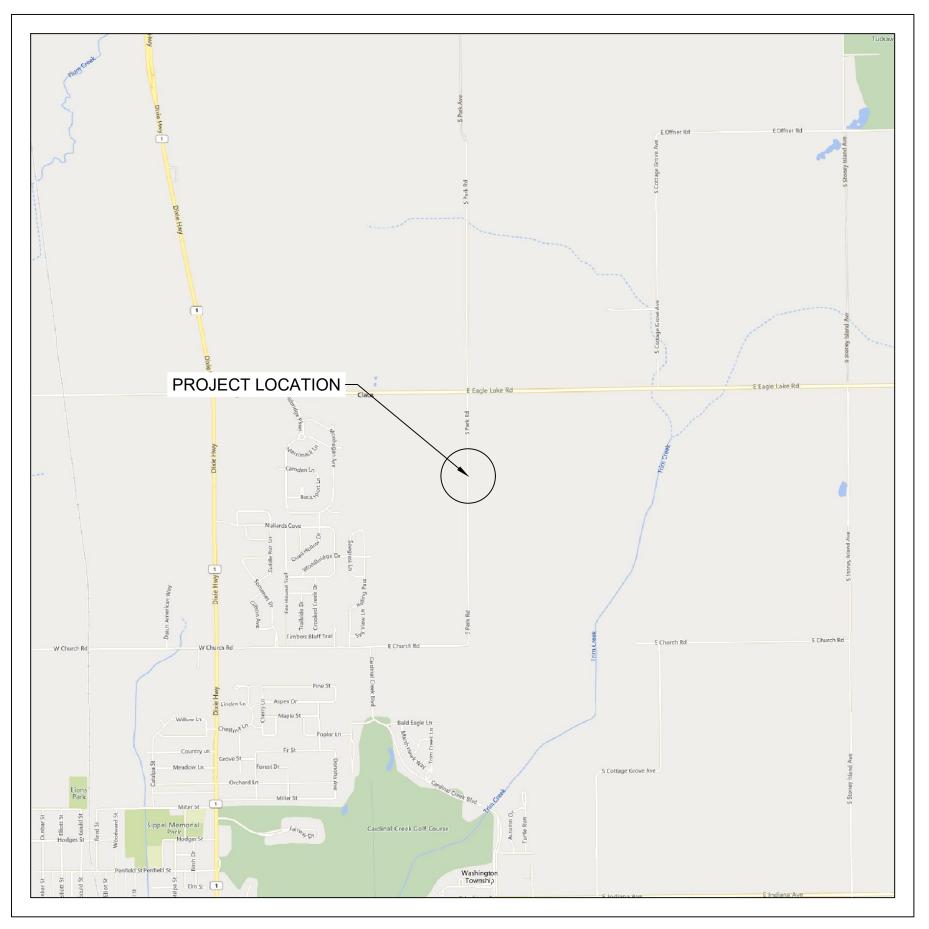



ARRAY LOCATION Scale: 1" = 2000'

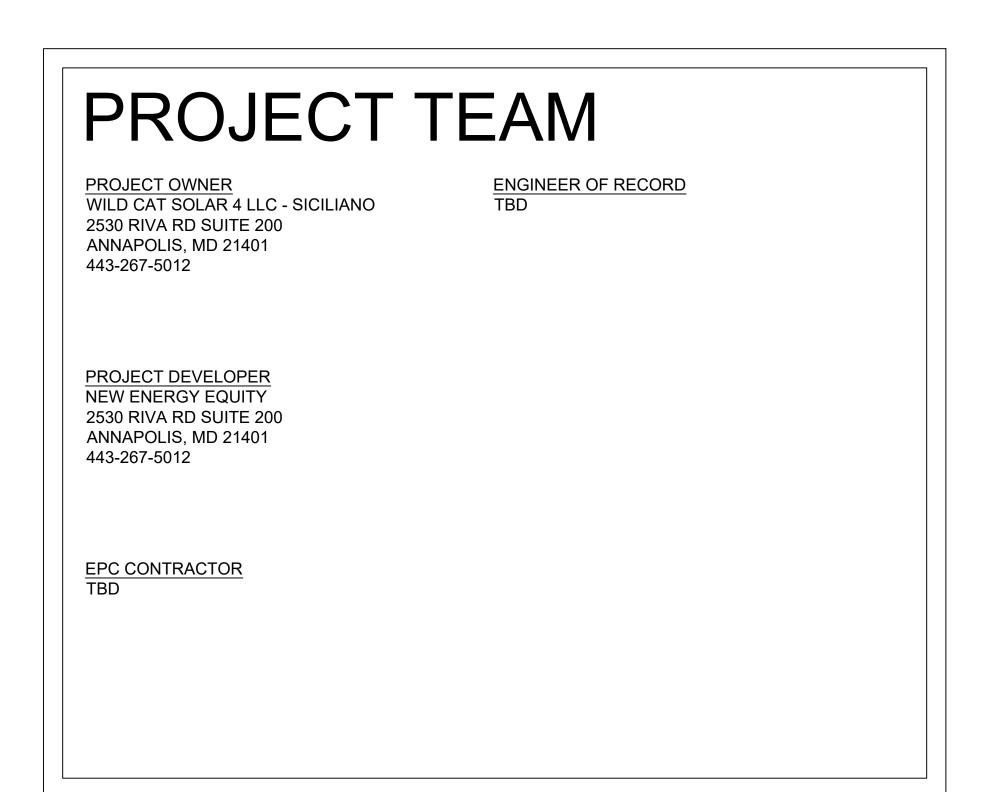

OVERHEAD MAP Scale: 1" = 300'

GENERAL INFO

PROJECT ACREAGE
ENTIRE PARCEL AREA: 120.66 ACRES
FENCE ACREAGE: 26.53 ACRES
LOT COVERAGE: 7.92% (AREA OF MODULES, ROAD & EQUIPMENT PADS DIVIDED BY PARCEL AREA)
FACILITY AREA ACREAGE: 35.8 ACRES

PARCEL DESCRIPTION
LAND OWNER: JAMES SICILIANO
PARCEL ID NUMBER: 2222101000050000

SHEET INDEX

SHEET#	DESCRIPTION	REVISION #	REVISION DATE
T1	TITLE PAGE	1	5/15/2024
PV1	EXISTING CONDITIONS	1	5/15/2024
PV2A	SITE PLAN A	1	5/15/2024
PV2B	SITE PLAN B	1	5/15/2024
PV3	PID & ZONING MAP	1	5/15/2024
PV4	SOIL MAP	1	5/15/2024
PV5	TOPOGRAPHY & DRAINAGE	1	5/15/2024
PV6	CONSTURCTION & MAINTENANCE ROUTES	1	5/15/2024
PV7	RACKING DETAIL	1	5/15/2024
PV8	FENCE DETAIL	1	5/15/2024
PV9	STORMWATER BASIN DETAIL	1	5/15/2024
E1A	SINGLE LINE DIAGRAM 1	1	5/15/2024
E1B	SINGLE LINE DIAGRAM 2	1	5/15/2024
E2A	SYSTEM LABELS 1	1	5/15/2024
E2B	SYSTEM LABELS 2	1	5/15/2024
E3	INTERCONNECTION DETAIL	1	5/15/2024
E4	EQUIPMENT DOCS 1	1	5/15/2024
E5	EQUIPMENT DOCS 2	1	5/15/2024
E6	EQUIPMENT DOCS 3	1	5/15/2024



PROJECT ENTITY: WILD CAT SOLAR 4 LLC - SICILIANC

NEW ENERGY EQUITY, LLC 2530 RIVA ROAD, SUITE 200 ANNAPOLIS, MD 21041 NEWENERGYEQUITY.COM

PROJECT ADDRESS 28964 S PARK AVE BEECHER, IL 60401

LAT: 41.365 LONG: -87.602

SYSTEM	SPECIFICATIONS
SYSTEM SIZE DC	7.378 MW
SYSTEM SIZE AC	POWER LIMITED TO 5.000 MW
DC/AC RATIO	1.476
AZIMUTH	180°
TILT	+/- 52°
MODULE COUNT	12720
MODULE TYPE	HANWHA Q.PEAK DUO XL-G11.3/BFG
MODULE STC RATING	580 W
INVERTER COUNT	34
INVERTER TYPE	SMA SUNNY HIGHPOWER PEAK-3 150kW
INVERTER POWER	POWER LIMITED TO 147.058 kW
RACKING	TBD
MONITORING	ALSO ENERGY

DESIGN CRITERIA			
MIN/MAX TEMP.	-22°C / 33°C		
WIND SPEED (ASCE 7-10)	105 MPH		
BUILDING CATEGORY	1		
EXPOSURE CATEGORY	С		
GROUND SNOW LOAD	25 PSF		
BUILDING HEIGHT	0'-0"		
	MIN/MAX TEMP. WIND SPEED (ASCE 7-10) BUILDING CATEGORY EXPOSURE CATEGORY GROUND SNOW LOAD		

OTHER NOTES
E-911 ADDRESS TO BE APPLIED FOR WIT
BUILDING PERMIT

NO POSITION, DISTANCE, OR CLEARANCISSUES WITH OVERHEAD ELECTRIC SERVICE LINES OR OTHER UTILITIES IN RELATION TO THE PV PANELS.

24/7 UNESCORTED KEYLESS ACCESS PROVIDED FOR ALL UTILITY ENERGY EQUIPMENT INCLUDING THE METERS AND AC DISCONNECT.

INTERCONNECTION TYPE: PRIMARY

REVISIONS				
#	DESCRIPTION	BY	DAT	
0	ORIGINAL DESIGN	SP	3/20/20	
1	CUP PACKAGE	SP	3/22/20	
2	ACCESS RD CHANGE	SP	4/5/20	
3	1.55 DC/AC RATIO CHANGE	SP	12/7/20	
4	SLD WYE-DELTA WYE	SP	3/14/20	
5	CUP REFRESH	SP	4/30/2	
6	GAS LINE ADDITION	SP	5/9/20	
7	VISUAL SCREENING PAGES	SP	5/28/20	
8				
9				
10				
11				

PROJECT NAME
SICILIANO

DRAWING TITLE

TITLE SHEET

SCALE

AS NOTED 0 1" 2

SHEET

T1





NEW ENERGY EQUITY, LLC 2530 RIVA ROAD, SUITE 200 ANNAPOLIS, MD 21041 NEWENERGYEQUITY.COM 443-267-5012

PROJECT ADDRESS 28964 S PARK AVE BEECHER, IL 60401

LAT: 41.365 LONG: -87.602

SPECIFICATIONS	SYSTEM
7.378 MW	SYSTEM SIZE DC
POWER LIMITED TO 5.000 MW	SYSTEM SIZE AC
1.476	DC/AC RATIO
180°	AZIMUTH
+/- 52°	TILT
12720	MODULE COUNT
HANWHA Q.PEAK DUO XL-G11.3/BFG	MODULE TYPE
580 W	MODULE STC RATING
34	INVERTER COUNT
SMA SUNNY HIGHPOWER PEAK 150kW	INVERTER TYPE
POWER LIMITED TO 147.058 kV	INVERTER POWER
TBD	RACKING
ALSO ENERGY	MONITORING

MIN/MAX TEMP22°C / 33°C WIND SPEED (ASCE 7-10) 105 MPH	DESIGN CRITERIA			
WIND SPEED (ASCE 7-10) 105 MPH				
(
BUILDING CATEGORY I				
EXPOSURE CATEGORY C				
GROUND SNOW LOAD 25 PSF				
BUILDING HEIGHT 0'-0"				

OTHER NOTES E-911 ADDRESS TO BE APPLIED FOR WITH BUILDING PERMIT

NO POSITION, DISTANCE, OR CLEARANCE ISSUES WITH OVERHEAD ELECTRIC SERVICE LINES OR OTHER UTILITIES IN RELATION TO THE PV PANELS.

24/7 UNESCORTED KEYLESS ACCESS PROVIDED FOR ALL UTILITY ENERGY
EQUIPMENT INCLUDING THE METERS AND
AC DISCONNECT.

INTERCONNECTION TYPE: PRIMARY

	REVISIONS		
#	DESCRIPTION	BY	DATE
0	ORIGINAL DESIGN	SP	3/20/2023
1	CUP PACKAGE	SP	3/22/2023
2	ACCESS RD CHANGE	SP	4/5/2023
3	1.55 DC/AC RATIO CHANGE	SP	12/7/2023
4	SLD WYE-DELTA WYE	SP	3/14/2024
5	CUP REFRESH	SP	4/30/2024
6	GAS LINE ADDITION	SP	5/9/2024
7	VISUAL SCREENING PAGES	SP	5/28/2024
8			
9			
10			
11			


PROJECT NAME SICILIANO

DRAWING TITLE

SITE PLAN

SCALE 1

SHEET

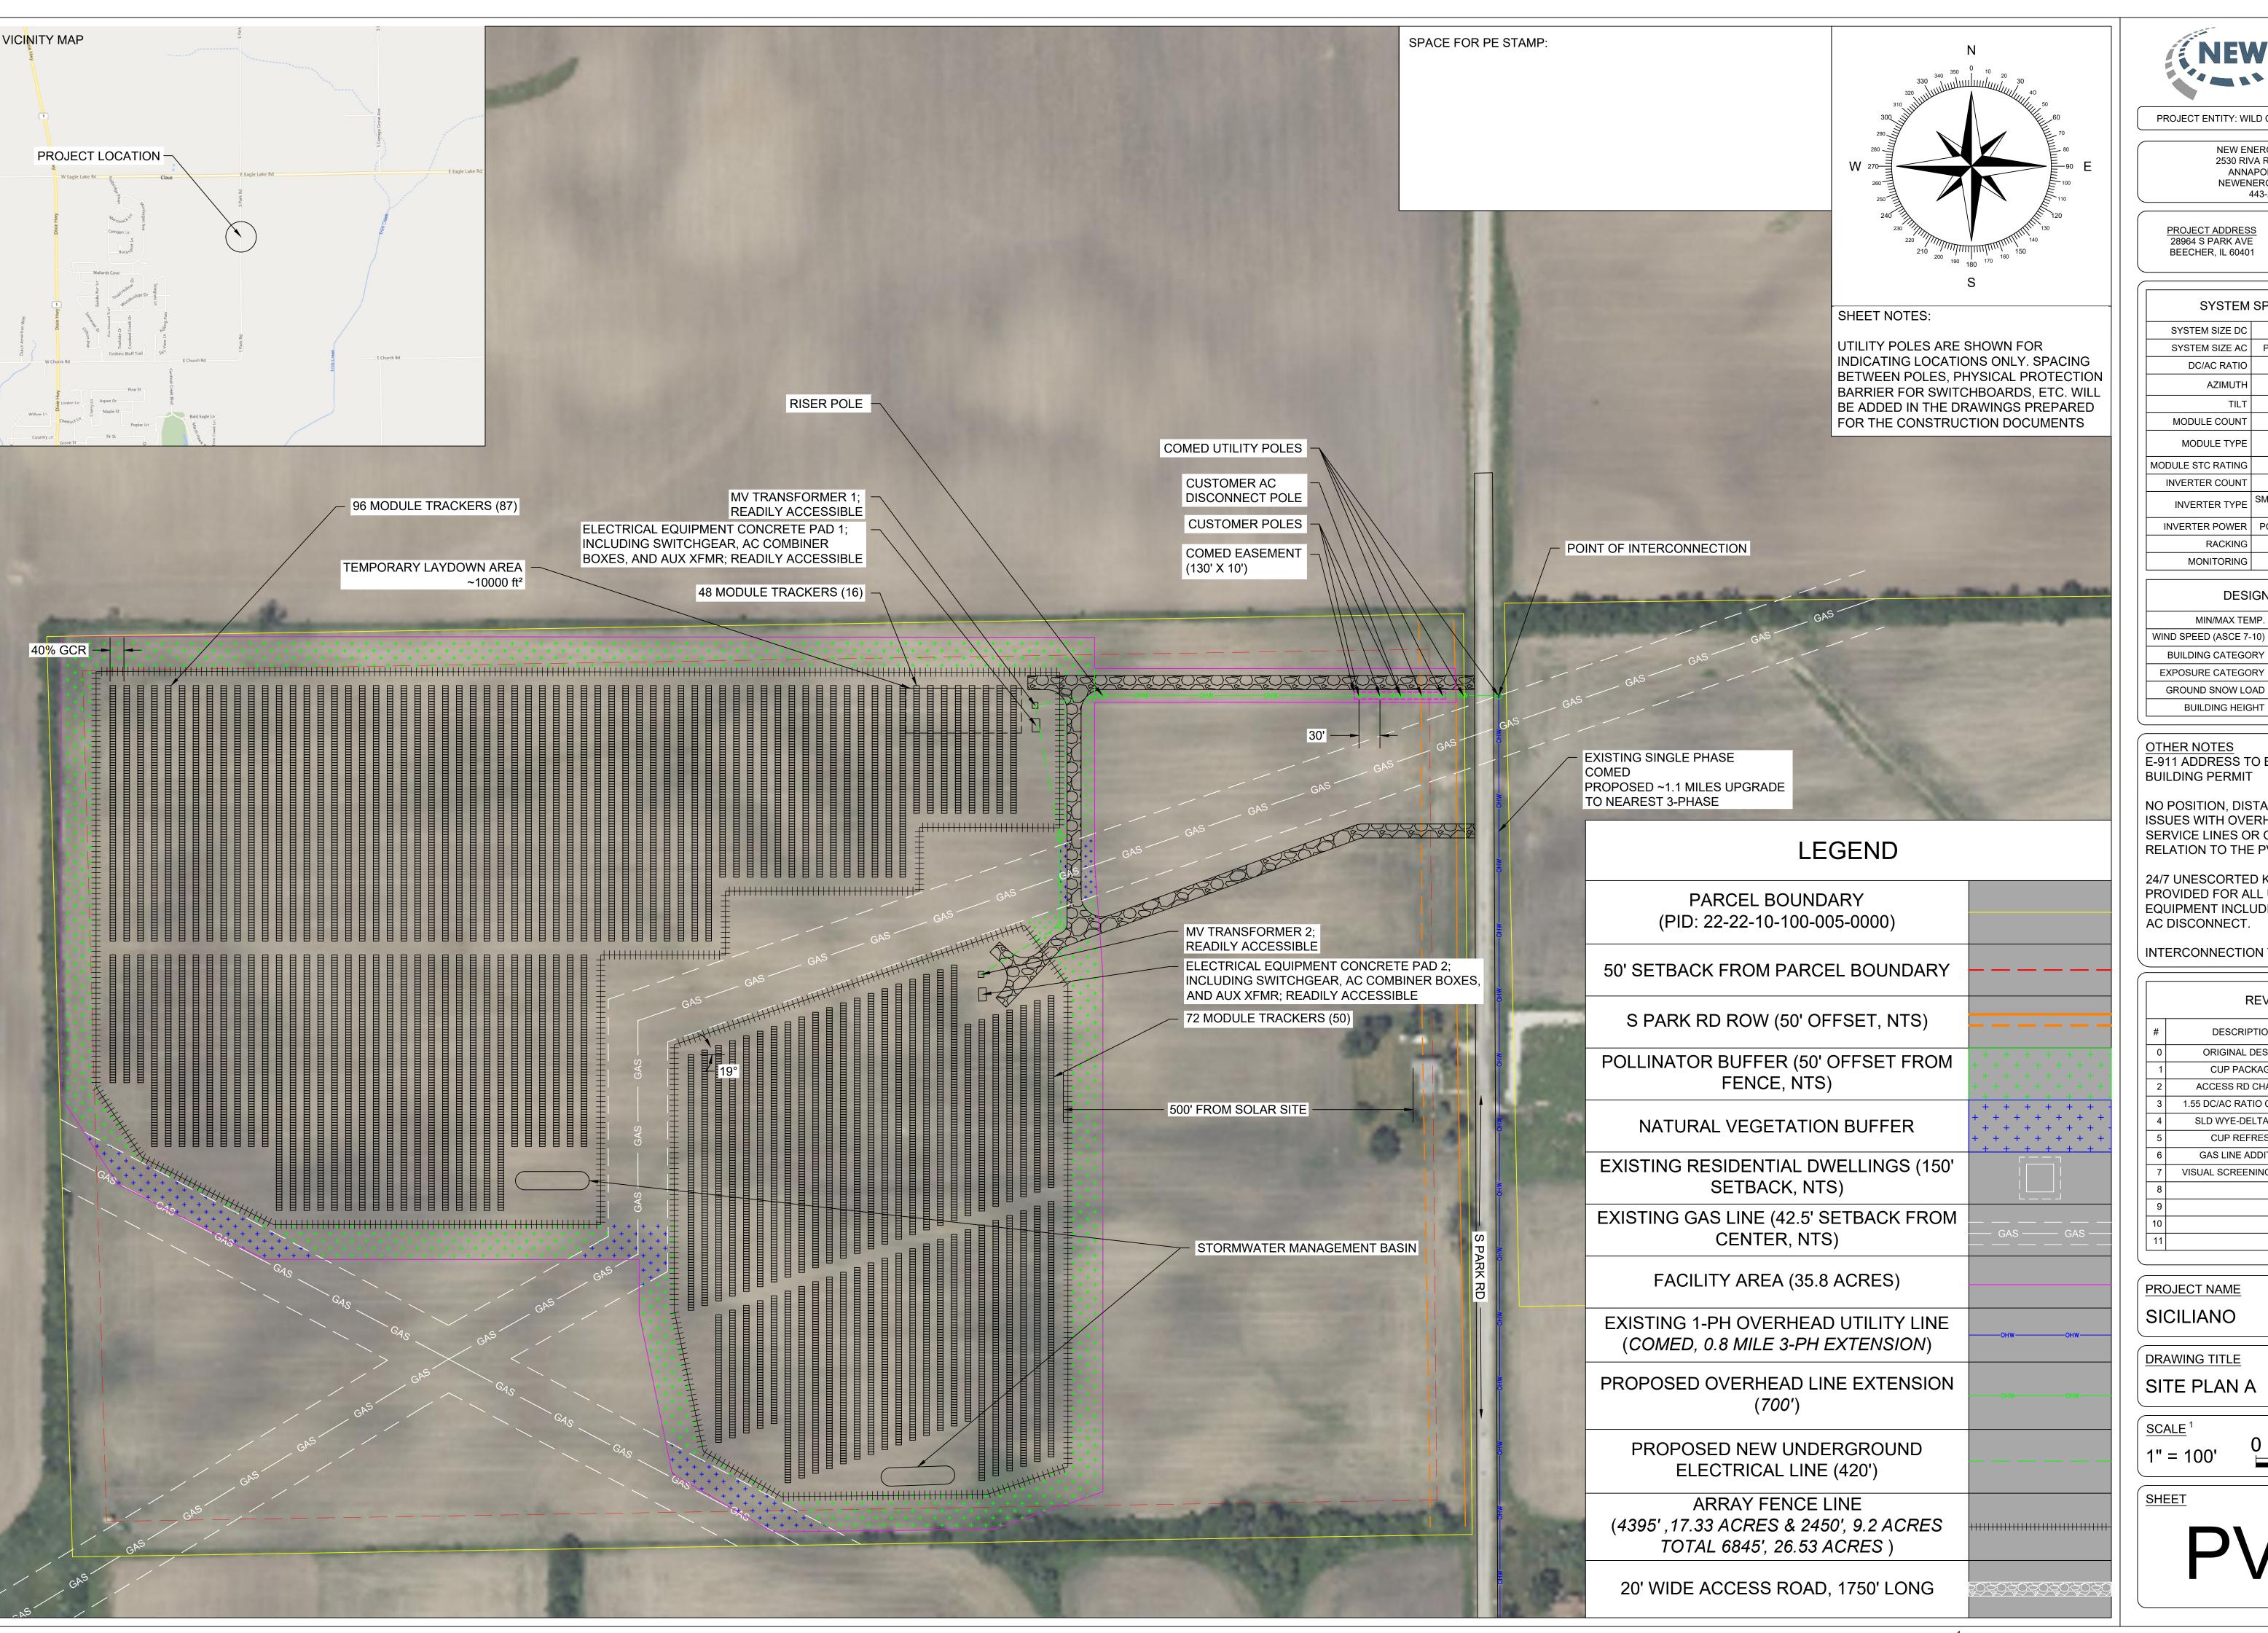



NEW ENERGY EQUITY, LLC 2530 RIVA ROAD, SUITE 200 ANNAPOLIS, MD 21041 NEWENERGYEQUITY.COM 443-267-5012

PROJECT ADDRESS 28964 S PARK AVE BEECHER, IL 60401

LAT: 41.365 LONG: -87.602

SYSTEM SIZE DC	7.378 MW
SYSTEM SIZE AC	POWER LIMITED TO 5.000 MW
DC/AC RATIO	1.476
AZIMUTH	180°
TILT	+/- 52°
MODULE COUNT	12720
MODULE TYPE	HANWHA Q.PEAK DUO XL-G11.3/BFG
MODULE STC RATING	580 W
INVERTER COUNT	34
INVERTER TYPE	SMA SUNNY HIGHPOWER PEAK-3 150kW
INVERTER POWER	POWER LIMITED TO 147.058 kW
RACKING	TBD
MONITORING ALSO ENERGY	

OTHER NOTES E-911 ADDRESS TO BE APPLIED FOR WITH

-22°C / 33°C

105 MPH

25 PSF

0'-0"

MIN/MAX TEMP.

BUILDING CATEGORY EXPOSURE CATEGORY GROUND SNOW LOAD

BUILDING HEIGHT

NO POSITION, DISTANCE, OR CLEARANCE ISSUES WITH OVERHEAD ELECTRIC SERVICE LINES OR OTHER UTILITIES IN RELATION TO THE PV PANELS.

24/7 UNESCORTED KEYLESS ACCESS PROVIDED FOR ALL UTILITY ENERGY EQUIPMENT INCLUDING THE METERS AND AC DISCONNECT.

INTERCONNECTION TYPE: PRIMARY

	REVISIONS		
#	DESCRIPTION	BY	DATE
0	ORIGINAL DESIGN	SP	3/20/2023
1	CUP PACKAGE	SP	3/22/2023
2	ACCESS RD CHANGE	SP	4/5/2023
3	1.55 DC/AC RATIO CHANGE	SP	12/7/2023
4	SLD WYE-DELTA WYE	SP	3/14/2024
5	CUP REFRESH	SP	4/30/2024
6	GAS LINE ADDITION	SP	5/9/2024
7	VISUAL SCREENING PAGES	SP	5/28/2024
8			
9			
10			
11			

PROJECT NAME SICILIANO


DRAWING TITLE

SITE PLAN A

SCALE 1

SHEET

PV2A

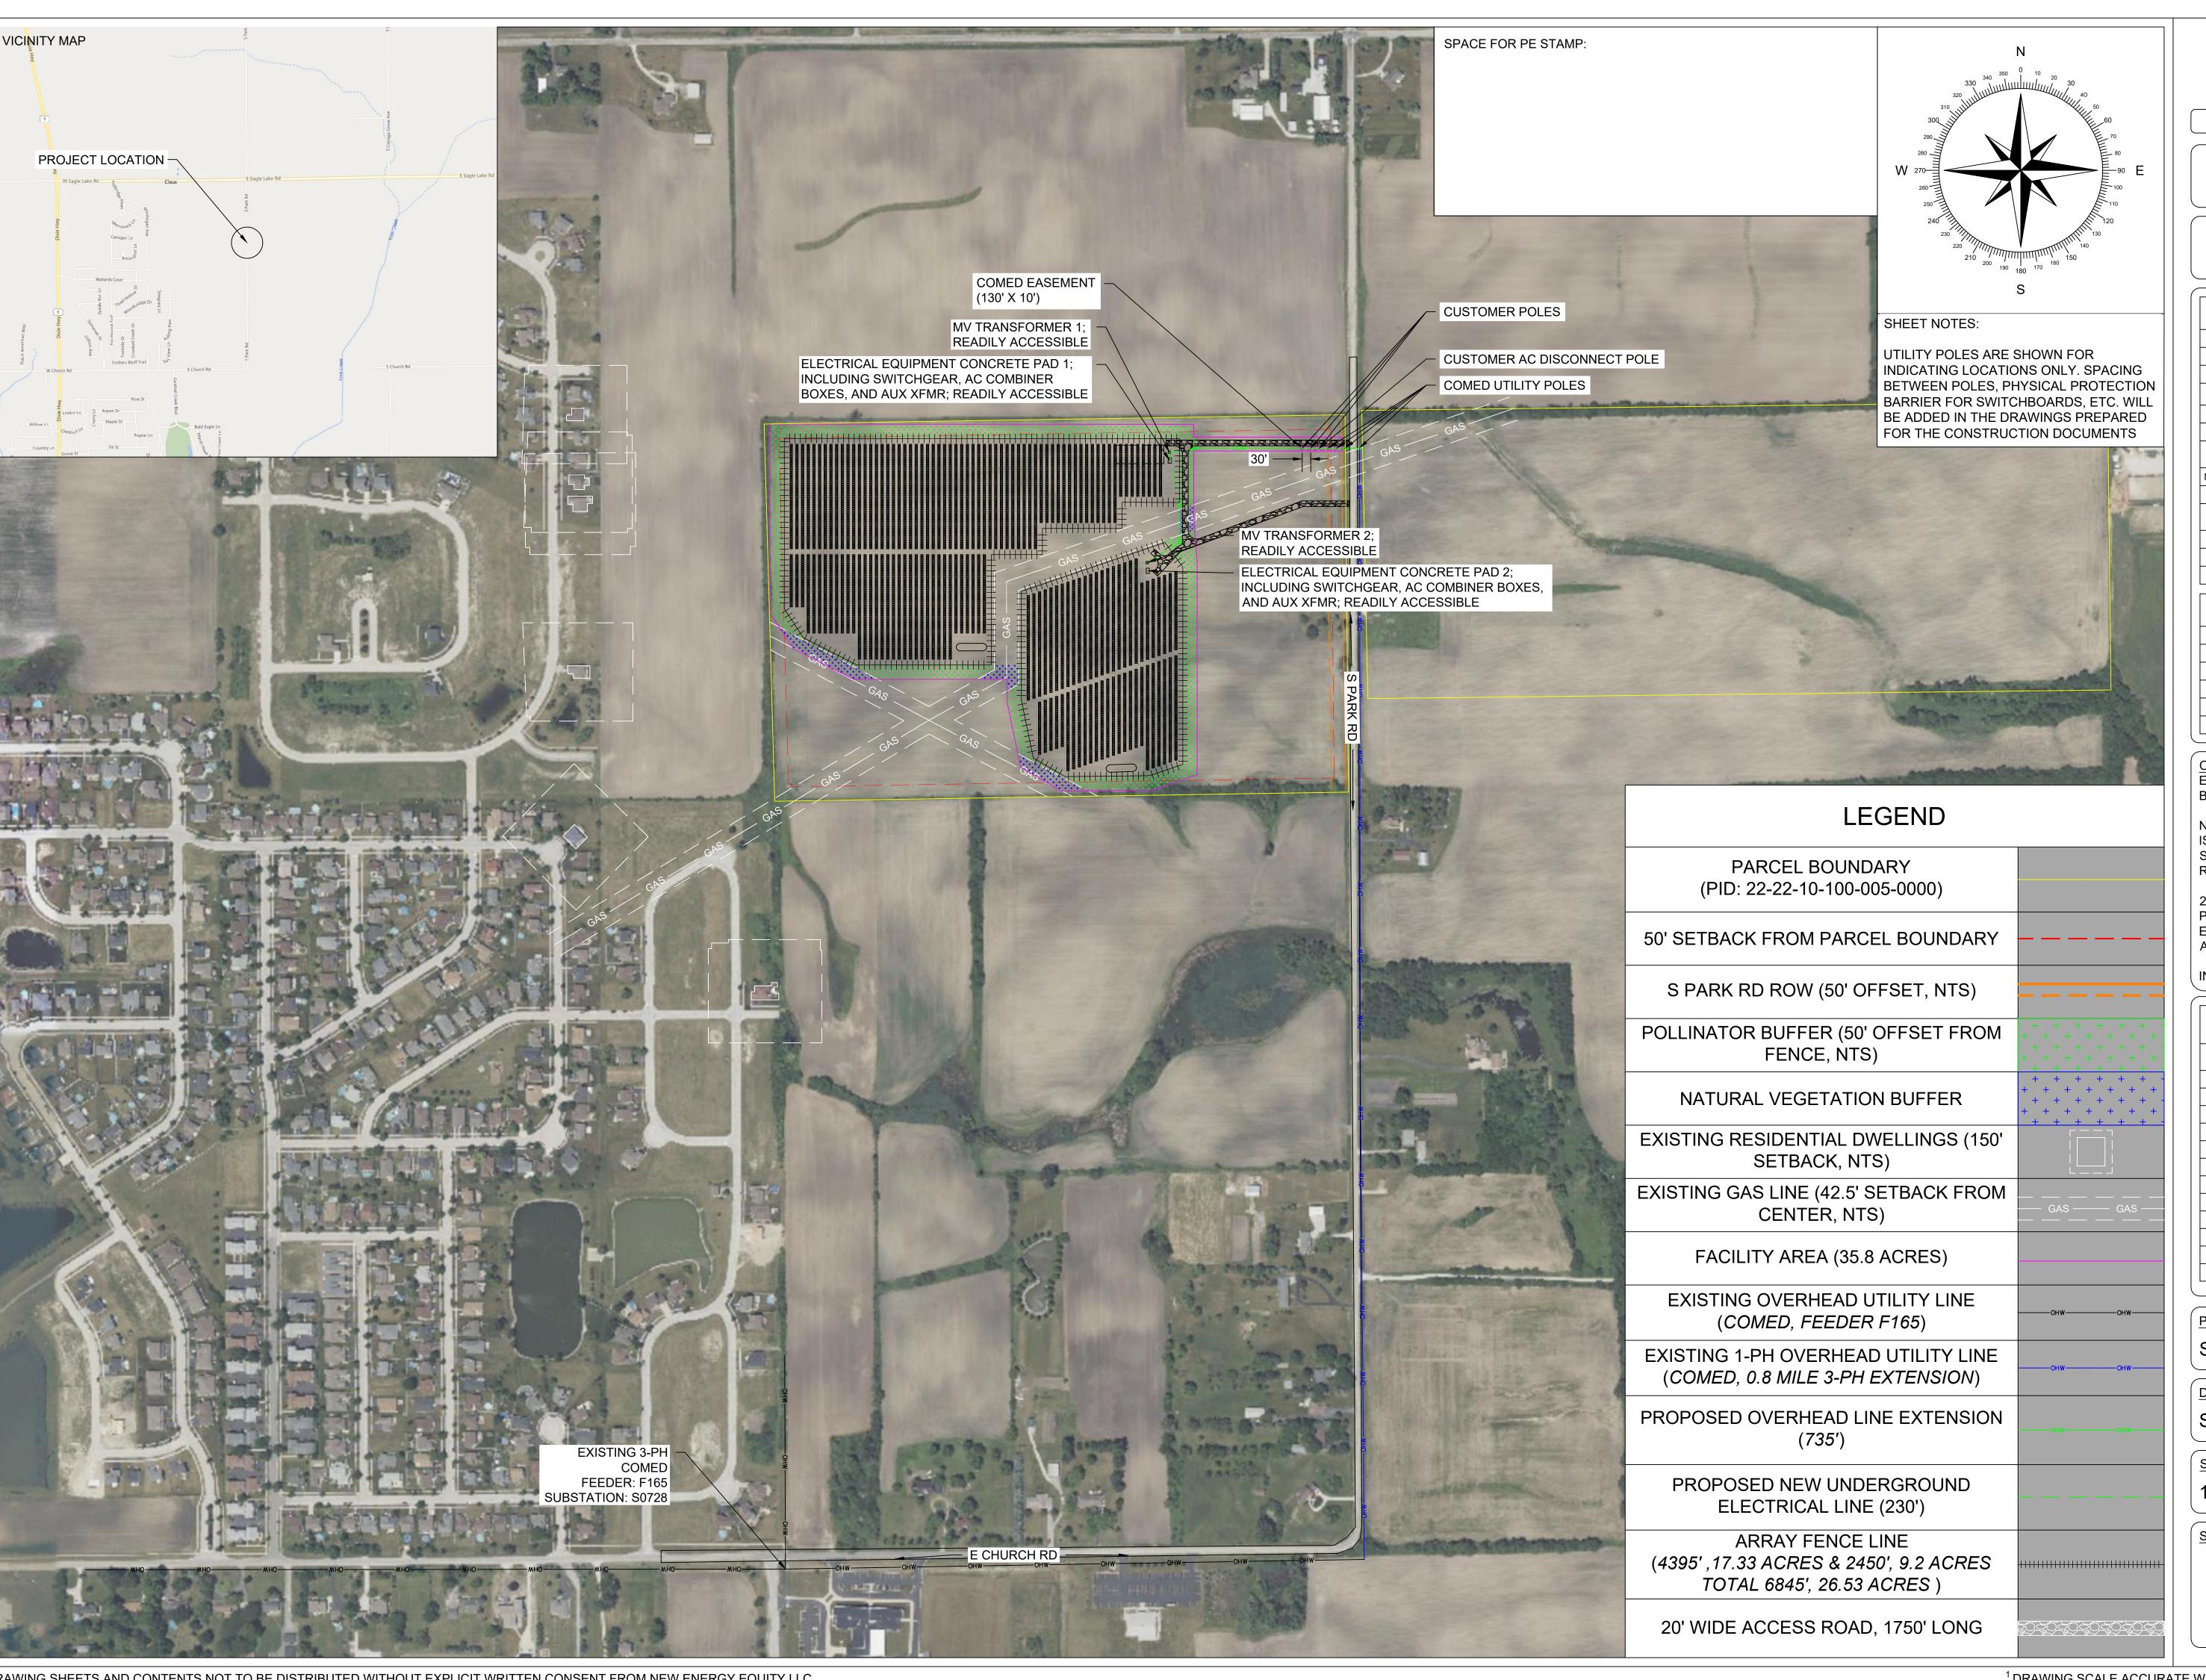



NEW ENERGY EQUITY, LLC 2530 RIVA ROAD, SUITE 200 ANNAPOLIS, MD 21041 NEWENERGYEQUITY.COM 443-267-5012

PROJECT ADDRESS 28964 S PARK AVE BEECHER, IL 60401

LAT: 41.365 LONG: -87.602

SYSTEM	SPECIFICATIONS
SYSTEM SIZE DC	7.378 MW
SYSTEM SIZE AC	POWER LIMITED TO 5.000 MW
DC/AC RATIO	1.476
AZIMUTH	180°
TILT	+/- 52°
MODULE COUNT	12720
MODULE TYPE	HANWHA Q.PEAK DUO XL-G11.3/BFG
MODULE STC RATING	580 W
INVERTER COUNT	34
INVERTER TYPE	SMA SUNNY HIGHPOWER PEAK-3 150kW
INVERTER POWER	POWER LIMITED TO 147.058 kW
RACKING	TBD
MONITORING	ALSO ENERGY

	DESIGN CRITERIA		
	MIN/MAX TEMP.	-22°C / 33°C	
	WIND SPEED (ASCE 7-10)	105 MPH	
	BUILDING CATEGORY	Ţ	
	EXPOSURE CATEGORY	С	
	GROUND SNOW LOAD	25 PSF	
	BUILDING HEIGHT	0'-0"	
(

OTHER NOTES E-911 ADDRESS TO BE APPLIED FOR WITH **BUILDING PERMIT**

NO POSITION, DISTANCE, OR CLEARANCE ISSUES WITH OVERHEAD ELECTRIC SERVICE LINES OR OTHER UTILITIES IN RELATION TO THE PV PANELS.

24/7 UNESCORTED KEYLESS ACCESS PROVIDED FOR ALL UTILITY ENERGY EQUIPMENT INCLUDING THE METERS AND AC DISCONNECT.

INTERCONNECTION TYPE: PRIMARY

	REVISIONS		
#	DESCRIPTION	BY	DATE
0	ORIGINAL DESIGN	SP	3/20/2023
1	CUP PACKAGE	SP	3/22/2023
2	ACCESS RD CHANGE	SP	4/5/2023
3	1.55 DC/AC RATIO CHANGE	SP	12/7/2023
4	SLD WYE-DELTA WYE	SP	3/14/2024
5	CUP REFRESH	SP	4/30/2024
6	GAS LINE ADDITION	SP	5/9/2024
7	VISUAL SCREENING PAGES	SP	5/28/2024
8			
9			
10			
11			

PROJECT NAME SICILIANO


DRAWING TITLE

SITE PLAN B

SCALE 1

SHEET

PV2B

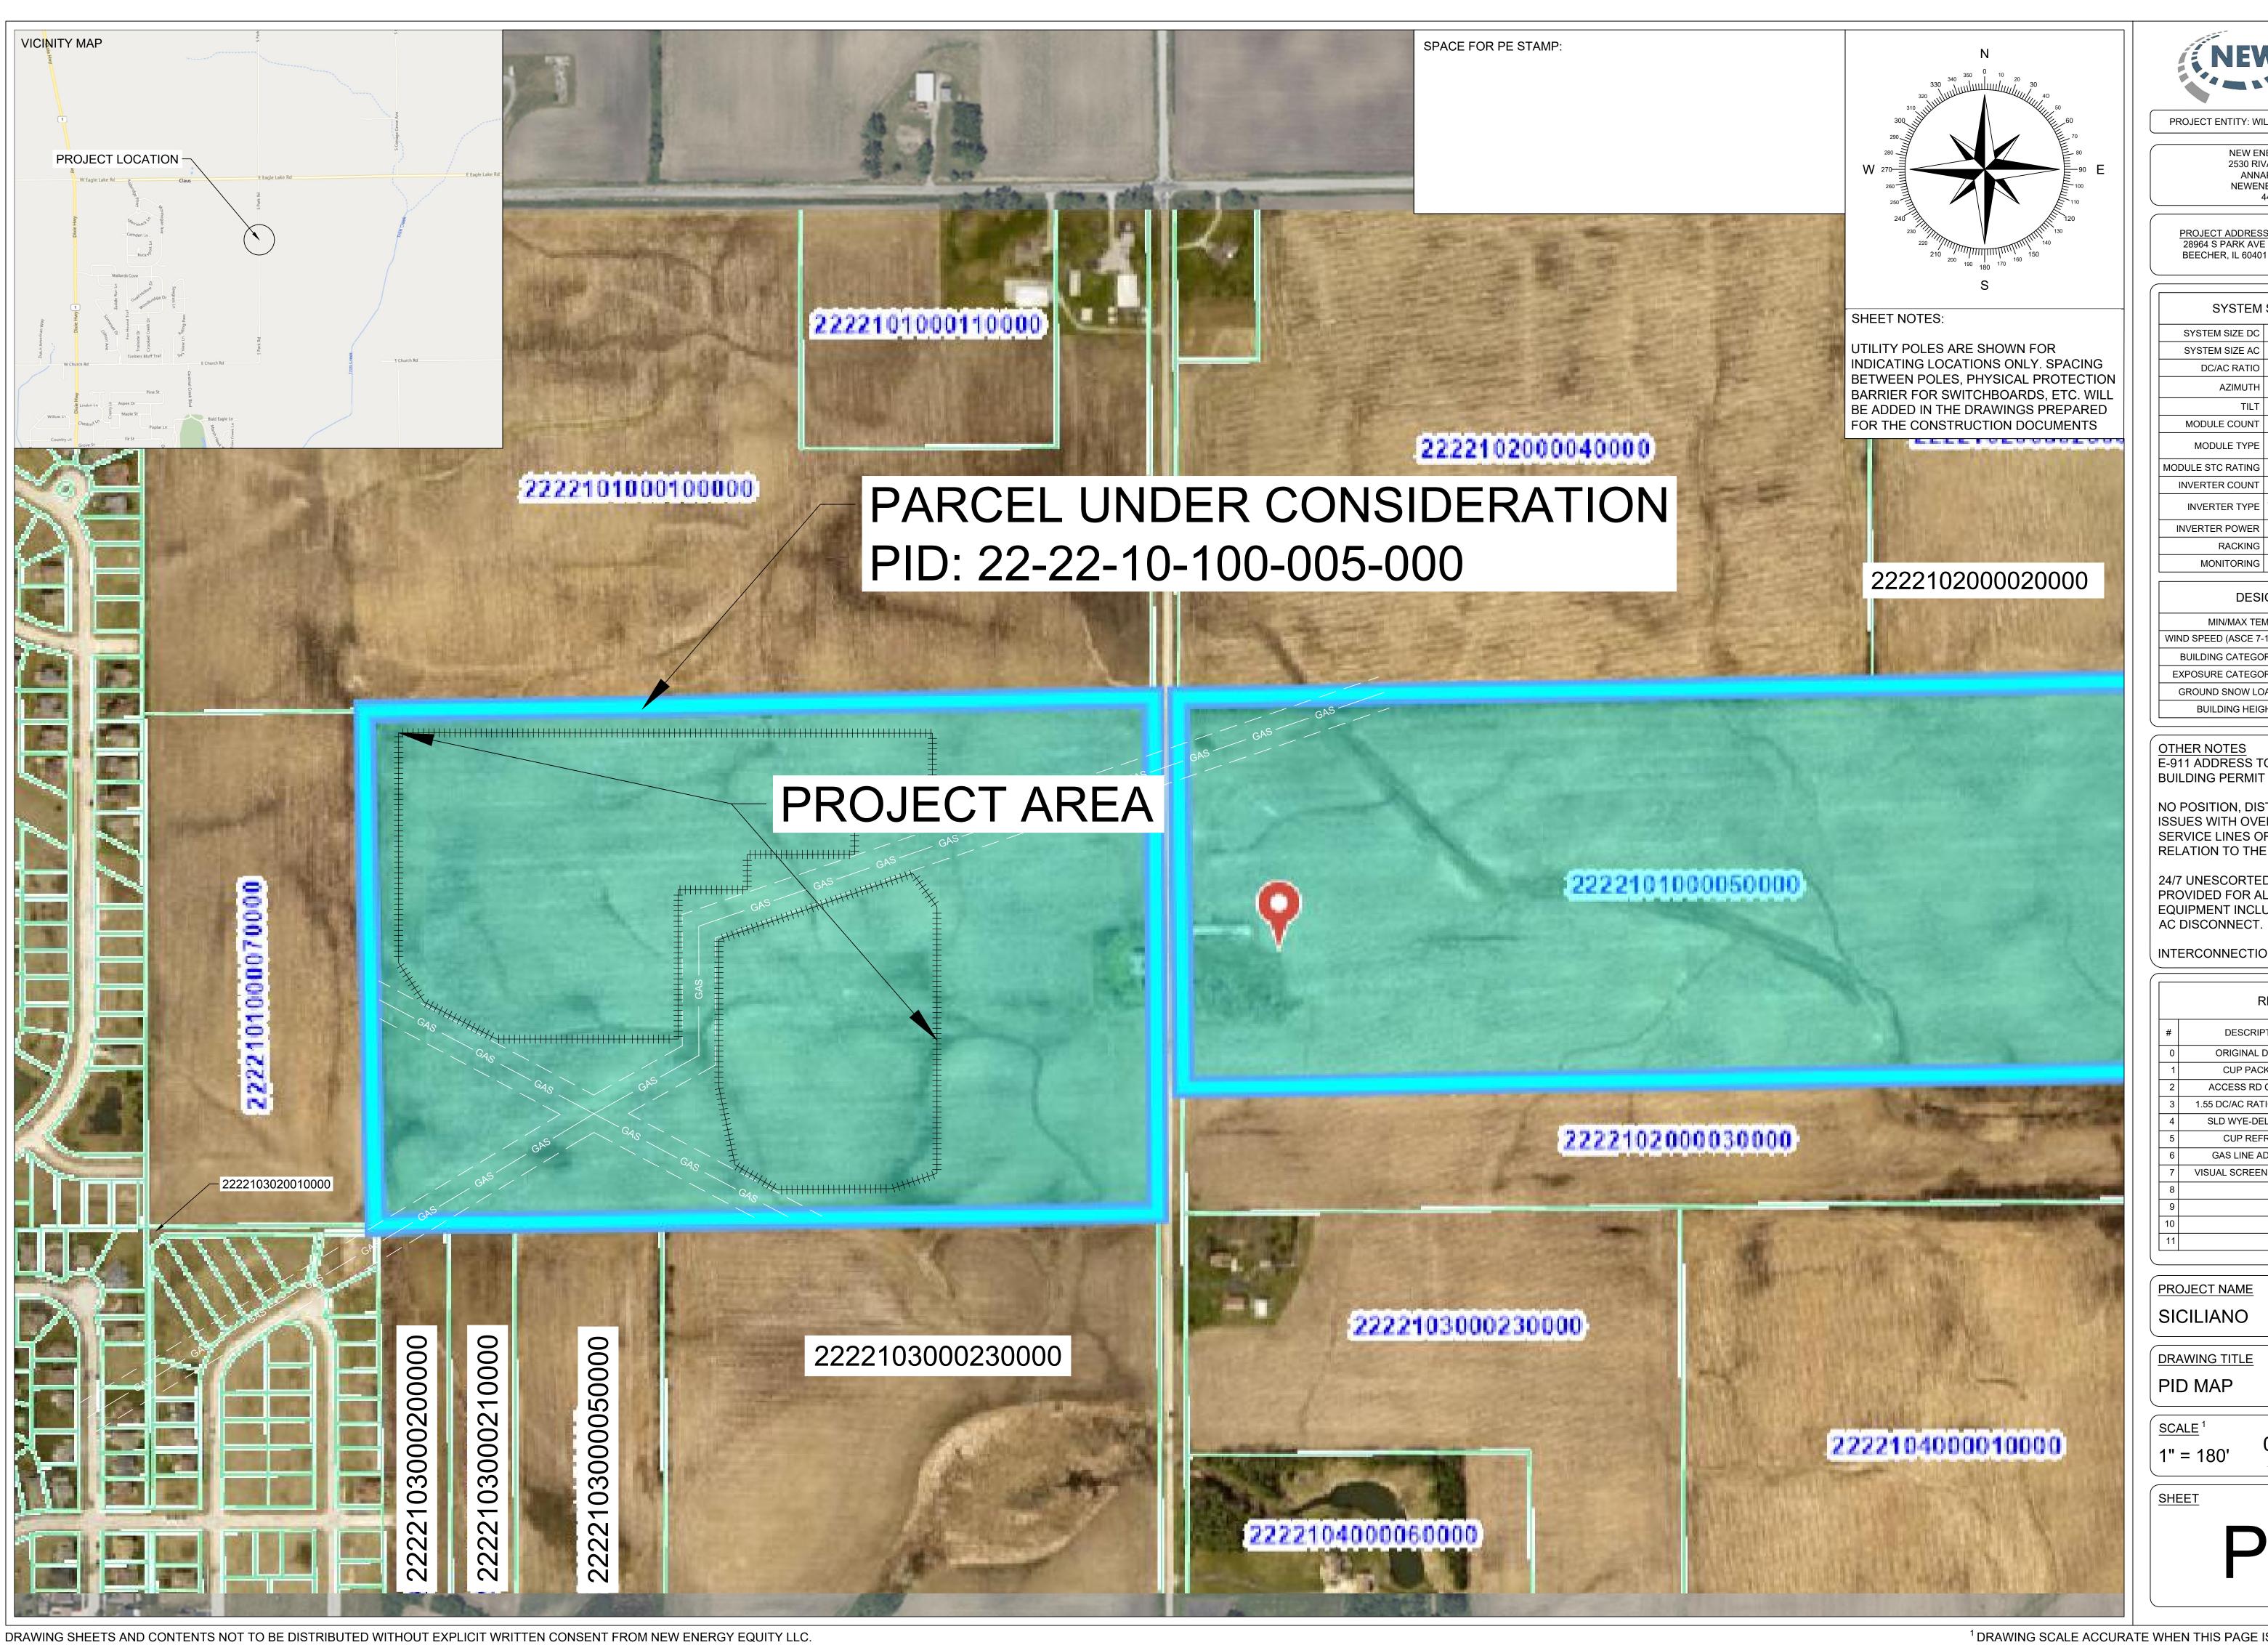

NEW ENERGY
EQUITY

NEWENERGYEQUITY.COM 443-267-5012

PROJECT ADDRESS 28964 S PARK AVE

LAT: 41.365 LONG: -87.602

SYSTEM SPECIFICATIONS				
SYSTEM SIZE DC	7.378 MW			
SYSTEM SIZE AC	POWER LIMITED TO 5.000 MW			
DC/AC RATIO	1.476			
AZIMUTH	180°			
TILT	+/- 52°			
MODULE COUNT	12720			
MODULE TYPE	HANWHA Q.PEAK DUO XL-G11.3/BFG			
MODULE STC RATING	580 W			
INVERTER COUNT	34			
INVERTER TYPE	SMA SUNNY HIGHPOWER PEAK-3 150kW			
INVERTER POWER	POWER LIMITED TO 147.058 kW			
RACKING	TBD			
MONITORING	ALSO ENERGY			

MIN/MAX TEMP22°C / 33°C WIND SPEED (ASCE 7-10) 105 MPH
WIND SPEED (ASCE 7-10) 105 MPH
BUILDING CATEGORY I
EXPOSURE CATEGORY C
GROUND SNOW LOAD 25 PSF
BUILDING HEIGHT 0'-0"

NO POSITION, DISTANCE, OR CLEARANCE ISSUES WITH OVERHEAD ELECTRIC SERVICE LINES OR OTHER UTILITIES IN RELATION TO THE PV PANELS.


24/7 UNESCORTED KEYLESS ACCESS PROVIDED FOR ALL UTILITY ENERGY EQUIPMENT INCLUDING THE METERS AND AC DISCONNECT.

INTERCONNECTION TYPE: PRIMARY

	REVISIONS		
#	DESCRIPTION	BY	DATE
0	ORIGINAL DESIGN	SP	3/20/2023
1	CUP PACKAGE	SP	3/22/2023
2	ACCESS RD CHANGE	SP	4/5/2023
3	1.55 DC/AC RATIO CHANGE	SP	12/7/2023
4	SLD WYE-DELTA WYE	SP	3/14/2024
5	CUP REFRESH	SP	4/30/2024
6	GAS LINE ADDITION	SP	5/9/2024
7	VISUAL SCREENING PAGES	SP	5/28/2024
8			
9			
10			
11			



PV3

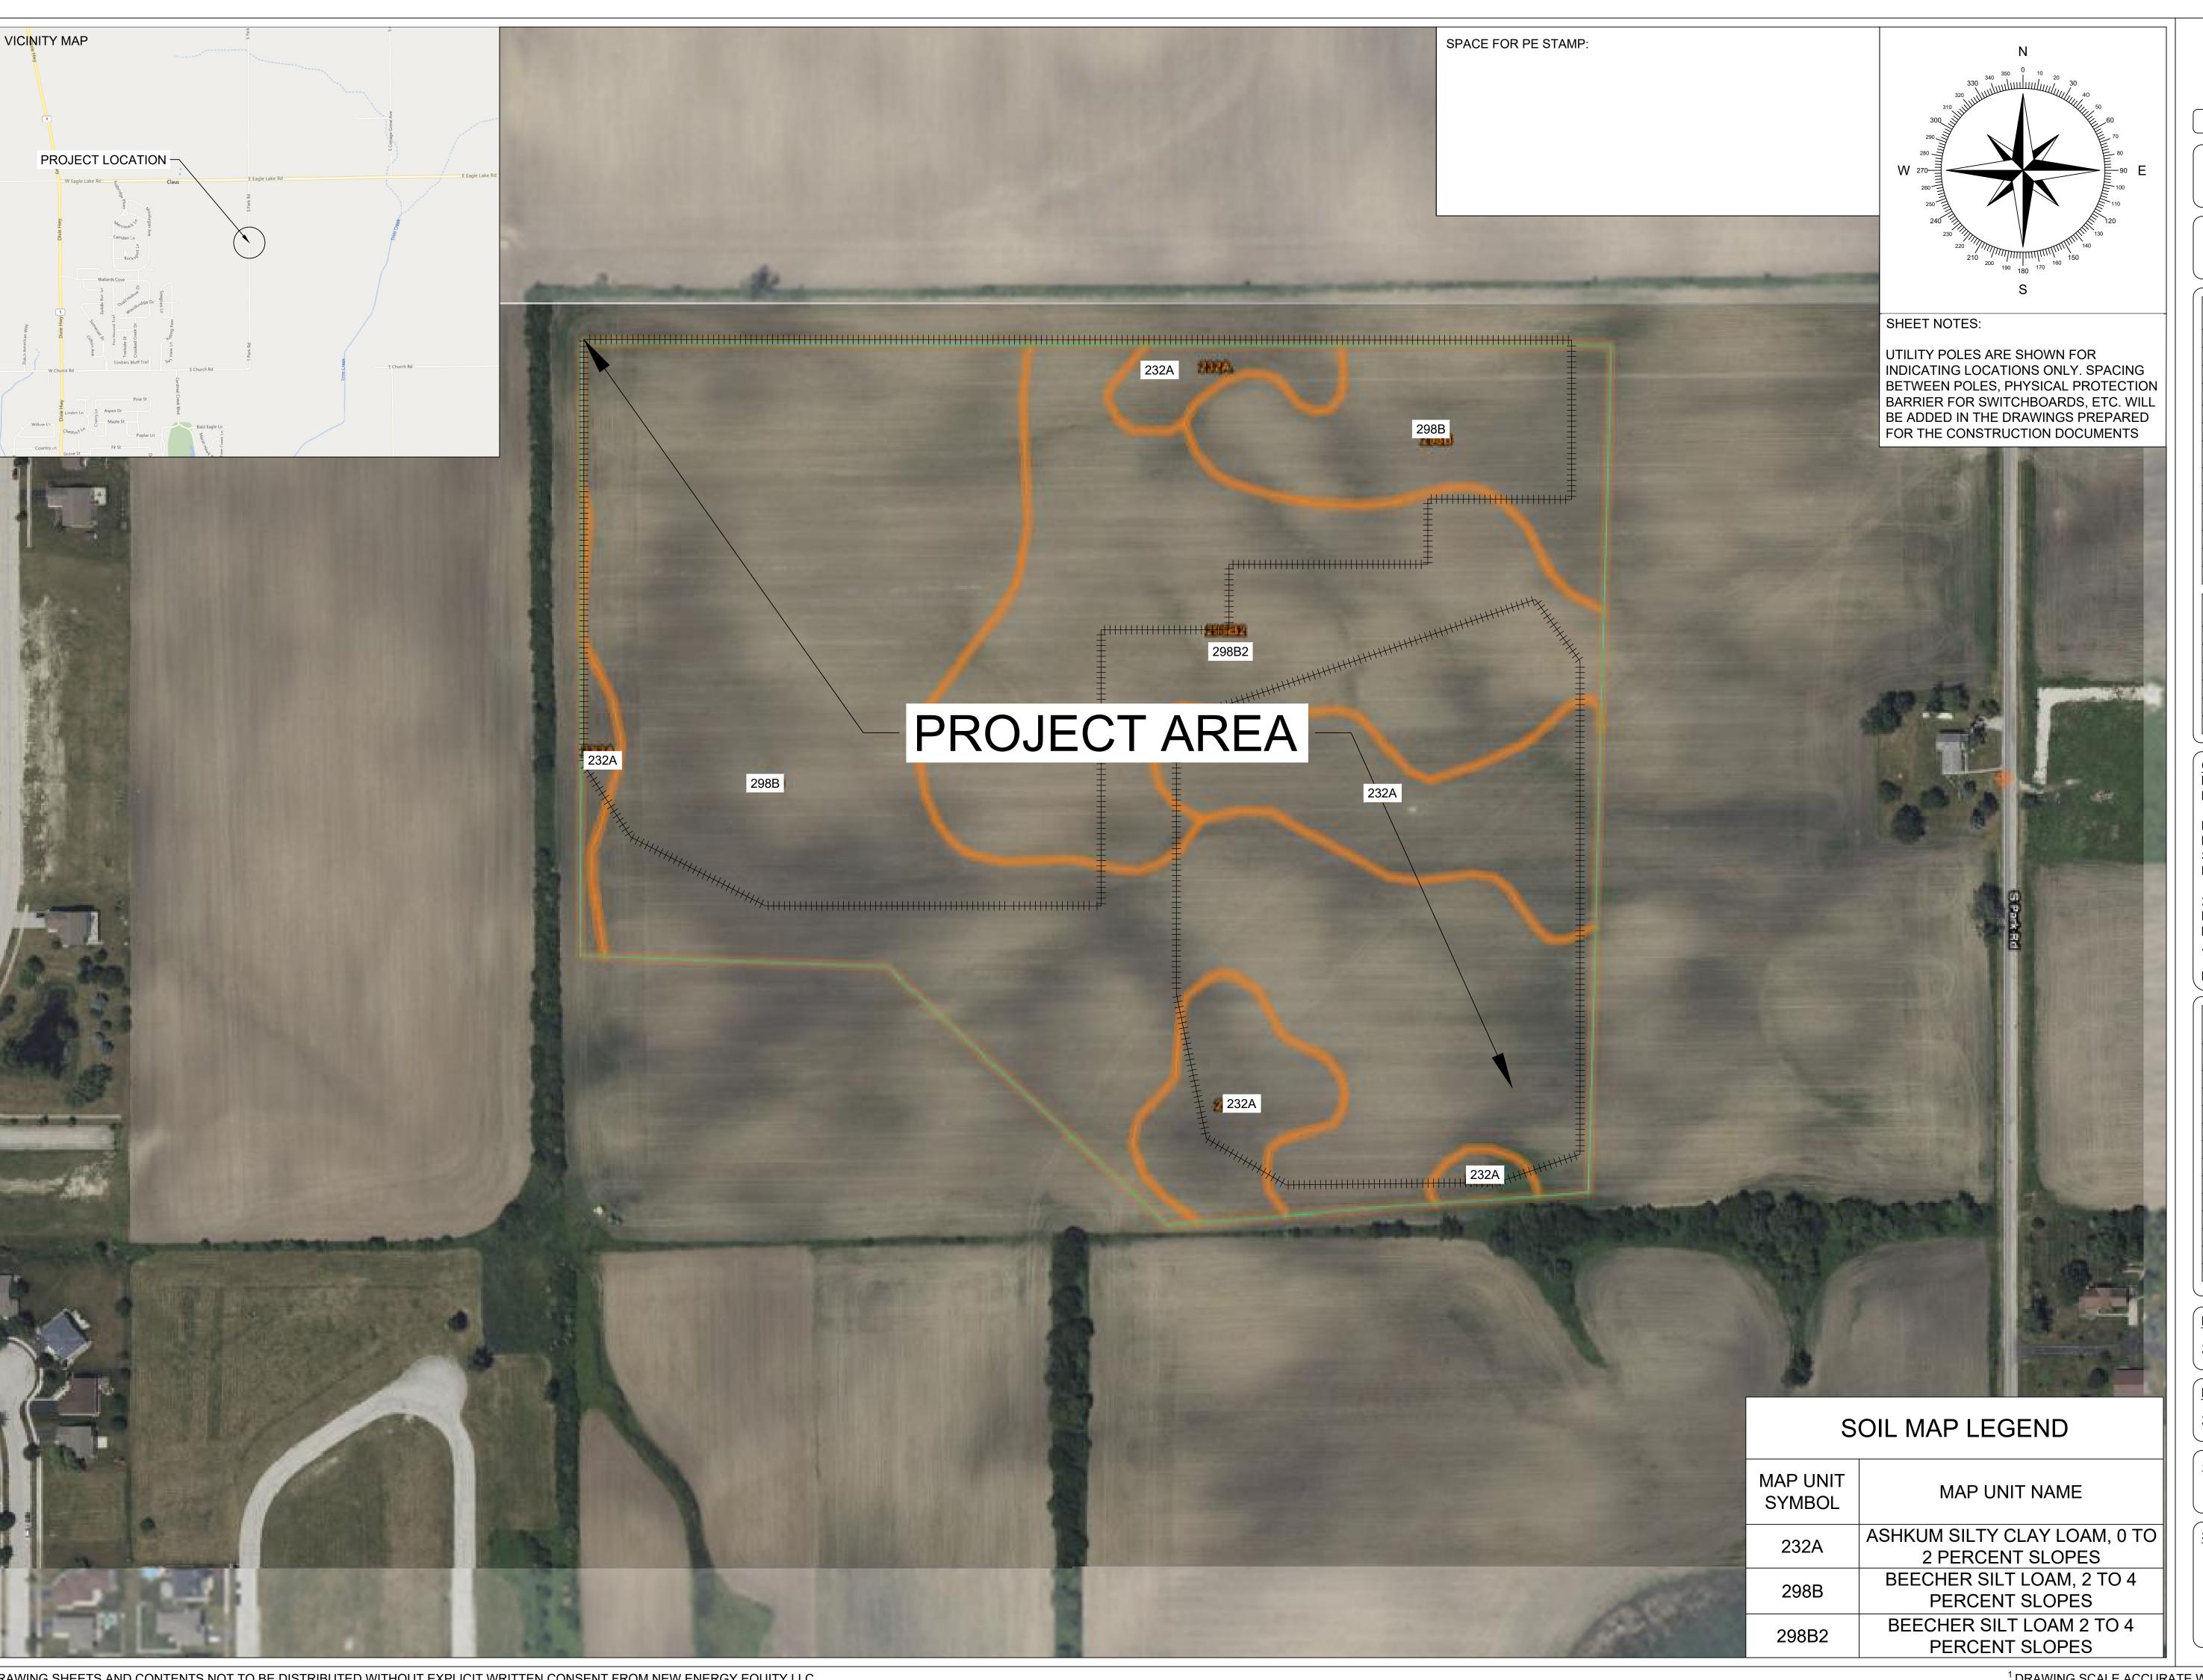



NEW ENERGY EQUITY, LLC 2530 RIVA ROAD, SUITE 200 ANNAPOLIS, MD 21041 NEWENERGYEQUITY.COM 443-267-5012

PROJECT ADDRESS 28964 S PARK AVE BEECHER, IL 60401

LAT: 41.365 LONG: -87.602

SPECIFICATIONS	SYSTEM
7.378 MW	SYSTEM SIZE DC
POWER LIMITED TO 5.000 MW	SYSTEM SIZE AC
1.476	DC/AC RATIO
180°	AZIMUTH
+/- 52°	TILT
12720	MODULE COUNT
HANWHA Q.PEAK DUO XL-G11.3/BFG	MODULE TYPE
580 W	MODULE STC RATING
34	INVERTER COUNT
SMA SUNNY HIGHPOWER PEAK-3 150kW	INVERTER TYPE
POWER LIMITED TO 147.058 kW	INVERTER POWER
TBD	RACKING
ALSO ENERGY	MONITORING

DESIGN CRITERIA		
MIN/MAX TEMP.	-22°C / 33°C	
WIND SPEED (ASCE 7-10)	105 MPH	
BUILDING CATEGORY	1	
EXPOSURE CATEGORY	С	
GROUND SNOW LOAD	25 PSF	
BUILDING HEIGHT	0'-0"	

OTHER NOTES E-911 ADDRESS TO BE APPLIED FOR WITH **BUILDING PERMIT**

NO POSITION, DISTANCE, OR CLEARANCE ISSUES WITH OVERHEAD ELECTRIC SERVICE LINES OR OTHER UTILITIES IN RELATION TO THE PV PANELS.

24/7 UNESCORTED KEYLESS ACCESS PROVIDED FOR ALL UTILITY ENERGY
EQUIPMENT INCLUDING THE METERS AND AC DISCONNECT.

INTERCONNECTION TYPE: PRIMARY


	REVISIONS		
#	DESCRIPTION	BY	DATE
0	ORIGINAL DESIGN	SP	3/20/2023
1	CUP PACKAGE	SP	3/22/2023
2	ACCESS RD CHANGE	SP	4/5/2023
3	1.55 DC/AC RATIO CHANGE	SP	12/7/2023
4	SLD WYE-DELTA WYE	SP	3/14/2024
5	CUP REFRESH	SP	4/30/2024
6	GAS LINE ADDITION	SP	5/9/2024
7	VISUAL SCREENING PAGES	SP	5/28/2024
8			
9			
10			
11			

PROJECT NAME SICILIANO

DRAWING TITLE

SOIL MAP

SCALE 1

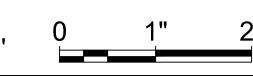

SHEET





NEW ENERGY EQUITY, LLC 2530 RIVA ROAD, SUITE 200 ANNAPOLIS, MD 21041 NEWENERGYEQUITY.COM 443-267-5012

PROJECT ADDRESS 28964 S PARK AVE BEECHER, IL 60401

LAT: 41.365 LONG: -87.602

SYSTEM	SPECIFICATIONS
SYSTEM SIZE DC	7.378 MW
SYSTEM SIZE AC	POWER LIMITED TO 5.000 MW
DC/AC RATIO	1.476
AZIMUTH	180°
TILT	+/- 52°
MODULE COUNT	12720
MODULE TYPE	HANWHA Q.PEAK DUO XL-G11.3/BFG
MODULE STC RATING	580 W
INVERTER COUNT	34
INVERTER TYPE	SMA SUNNY HIGHPOWER PEAK-3 150kW
INVERTER POWER	POWER LIMITED TO 147.058 kW
RACKING	TBD
MONITORING	ALSO ENERGY

DESIGN CRITERIA		
MIN/MAX TEMP.	-22°C / 33°C	
WIND SPEED (ASCE 7-10)	105 MPH	
BUILDING CATEGORY	1	
EXPOSURE CATEGORY	С	
GROUND SNOW LOAD	25 PSF	
BUILDING HEIGHT	0'-0"	

OTHER NOTES E-911 ADDRESS TO BE APPLIED FOR WITH BUILDING PERMIT

NO POSITION, DISTANCE, OR CLEARANCE ISSUES WITH OVERHEAD ELECTRIC SERVICE LINES OR OTHER UTILITIES IN RELATION TO THE PV PANELS.

24/7 UNESCORTED KEYLESS ACCESS PROVIDED FOR ALL UTILITY ENERGY
EQUIPMENT INCLUDING THE METERS AND
AC DISCONNECT.

INTERCONNECTION TYPE: PRIMARY

	REVISIONS					
# DESCRIPTION		BY	DATE			
0	ORIGINAL DESIGN	SP	3/20/2023			
1	CUP PACKAGE	SP	3/22/2023			
2	2 ACCESS RD CHANGE		4/5/2023			
3	3 1.55 DC/AC RATIO CHANGE		12/7/2023			
4	SLD WYE-DELTA WYE	SP	3/14/2024			
5	CUP REFRESH	SP	4/30/2024			
6	GAS LINE ADDITION	SP	5/9/2024			
7	VISUAL SCREENING PAGES	SP	5/28/2024			
8						
9						
10						
11						

PROJECT NAME

SICILIANO

DRAWING TITLE

TOPOGRAPHY & DRAINAGE





NEW ENERGY EQUITY, LLC 2530 RIVA ROAD, SUITE 200 ANNAPOLIS, MD 21041 NEWENERGYEQUITY.COM 443-267-5012

PROJECT ADDRESS 28964 S PARK AVE BEECHER, IL 60401

LAT: 41.365 LONG: -87.602

SYSTEM SPECIFICATIONS		
SYSTEM SIZE DC	7.378 MW	
SYSTEM SIZE AC	POWER LIMITED TO 5.000 MW	
DC/AC RATIO	1.476	
AZIMUTH	180°	
TILT	+/- 52°	
MODULE COUNT	12720	
MODULE TYPE	HANWHA Q.PEAK DUO XL-G11.3/BFG	
MODULE STC RATING	580 W	
INVERTER COUNT	34	
INVERTER TYPE	SMA SUNNY HIGHPOWER PEAK-3 150kW	
INVERTER POWER	POWER LIMITED TO 147.058 kW	
RACKING	TBD	
MONITORING	ALSO ENERGY	

	DESIGN CRITERIA				
	MIN/MAX TEMP.	-22°C / 33°C			
	WIND SPEED (ASCE 7-10)	105 MPH			
	BUILDING CATEGORY	I			
	EXPOSURE CATEGORY	С			
	GROUND SNOW LOAD	25 PSF			
BUILDING HEIGHT 0'-0"		0'-0"			

OTHER NOTES E-911 ADDRESS TO BE APPLIED FOR WITH BUILDING PERMIT

NO POSITION, DISTANCE, OR CLEARANCE ISSUES WITH OVERHEAD ELECTRIC SERVICE LINES OR OTHER UTILITIES IN RELATION TO THE PV PANELS.

24/7 UNESCORTED KEYLESS ACCESS PROVIDED FOR ALL UTILITY ENERGY EQUIPMENT INCLUDING THE METERS AND AC DISCONNECT.

INTERCONNECTION TYPE: PRIMARY

	REVISIONS					
# DESCRIPTION BY		DATE				
0	ORIGINAL DESIGN	SP	3/20/2023			
1	CUP PACKAGE	SP	3/22/2023			
2	2 ACCESS RD CHANGE		4/5/2023			
3	3 1.55 DC/AC RATIO CHANGE		12/7/2023			
4	4 SLD WYE-DELTA WYE		3/14/2024			
5 CUP REFRESH		SP	4/30/2024			
6	6 GAS LINE ADDITION		5/9/2024			
7	VISUAL SCREENING PAGES	SP	5/28/2024			
8						
9						
10						
11						

PROJECT NAME


SICILIANO


DRAWING TITLE

CONSTURCTION & MAINTENANCE ROUTES


SCALE 1

SHEET

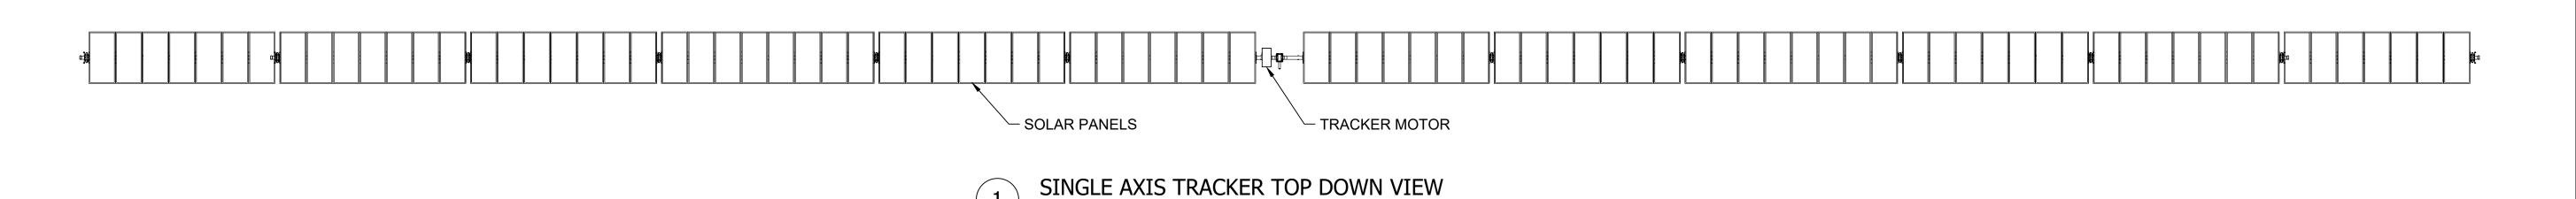

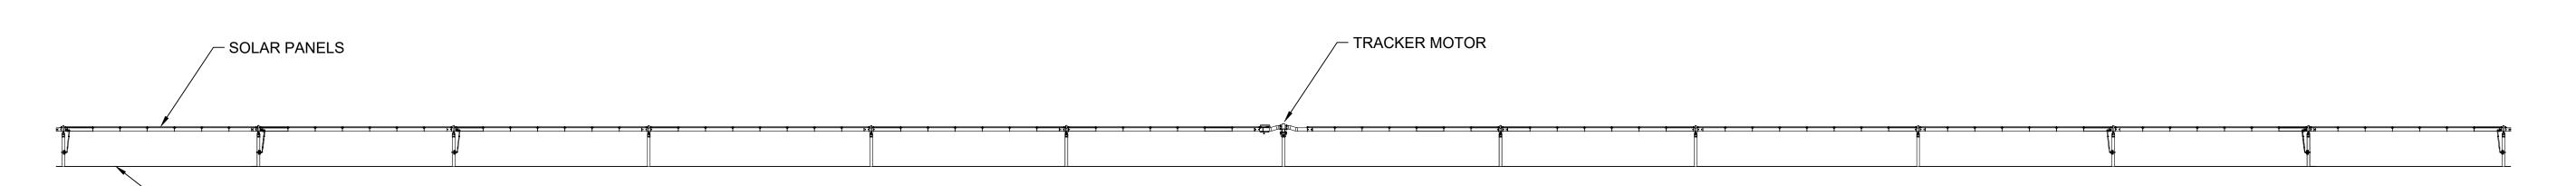

2 SINGLE AXIS TRACKER EAST-WEST ELEVATION NTS

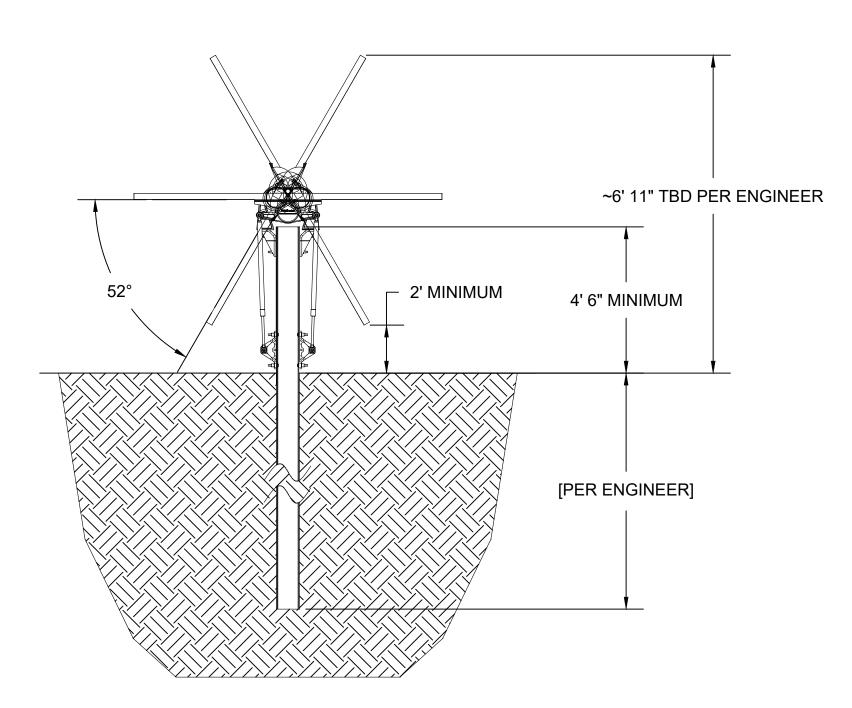

3 SINGLE AXIS TRACKER NORTH-SOUTH ELEVATION NTS



PROJECT ENTITY: WILD CAT SOLAR 4 LLC - SICILIANO

NEW ENERGY EQUITY, LLC 2530 RIVA ROAD, SUITE 200 ANNAPOLIS, MD 21041 NEWENERGYEQUITY.COM 443-267-5012

PROJECT ADDRESS 28964 S PARK AVE BEECHER, IL 60401

LAT: 41.365 LONG: -87.602

SYSTEM SPECIFICATIONS		
SYSTEM SIZE DC	7.378 MW	
SYSTEM SIZE AC	POWER LIMITED TO 5.000 MW	
DC/AC RATIO	1.476	
AZIMUTH	180°	
TILT	+/- 52°	
MODULE COUNT	12720	
MODULE TYPE	HANWHA Q.PEAK DUO XL-G11.3/BFG	
MODULE STC RATING	580 W	
INVERTER COUNT	34	
INVERTER TYPE	SMA SUNNY HIGHPOWER PEAK-3 150kW	
INVERTER POWER	POWER LIMITED TO 147.058 kW	
RACKING	TBD	
MONITORING	ALSO ENERGY	

DESIGN CRITERIA		
-22°C / 33°C		
105 MPH		
I		
С		
25 PSF		
0'-0"		

OTHER NOTES
E-911 ADDRESS TO BE APPLIED FOR WITH
BUILDING PERMIT

NO POSITION, DISTANCE, OR CLEARANCE ISSUES WITH OVERHEAD ELECTRIC SERVICE LINES OR OTHER UTILITIES IN RELATION TO THE PV PANELS.

24/7 UNESCORTED KEYLESS ACCESS
PROVIDED FOR ALL UTILITY ENERGY
EQUIPMENT INCLUDING THE METERS AND
AC DISCONNECT.

INTERCONNECTION TYPE: PRIMARY

REVISIONS			
# DESCRIPTION		BY	DATE
0	ORIGINAL DESIGN	SP	3/20/202
1	CUP PACKAGE	SP	3/22/202
2	ACCESS RD CHANGE	SP	4/5/202
3	1.55 DC/AC RATIO CHANGE	SP	12/7/202
4	SLD WYE-DELTA WYE	SP	3/14/202
5	CUP REFRESH	SP	4/30/202
6	GAS LINE ADDITION	SP	5/9/202
7	VISUAL SCREENING PAGES	SP	5/28/202
8			
9			
10			
11			

PROJECT NAME

SICILIANO

DRAWING TITLE


SAT RACKING DETAIL

SCALE 1


NTS

SHEET

PV7

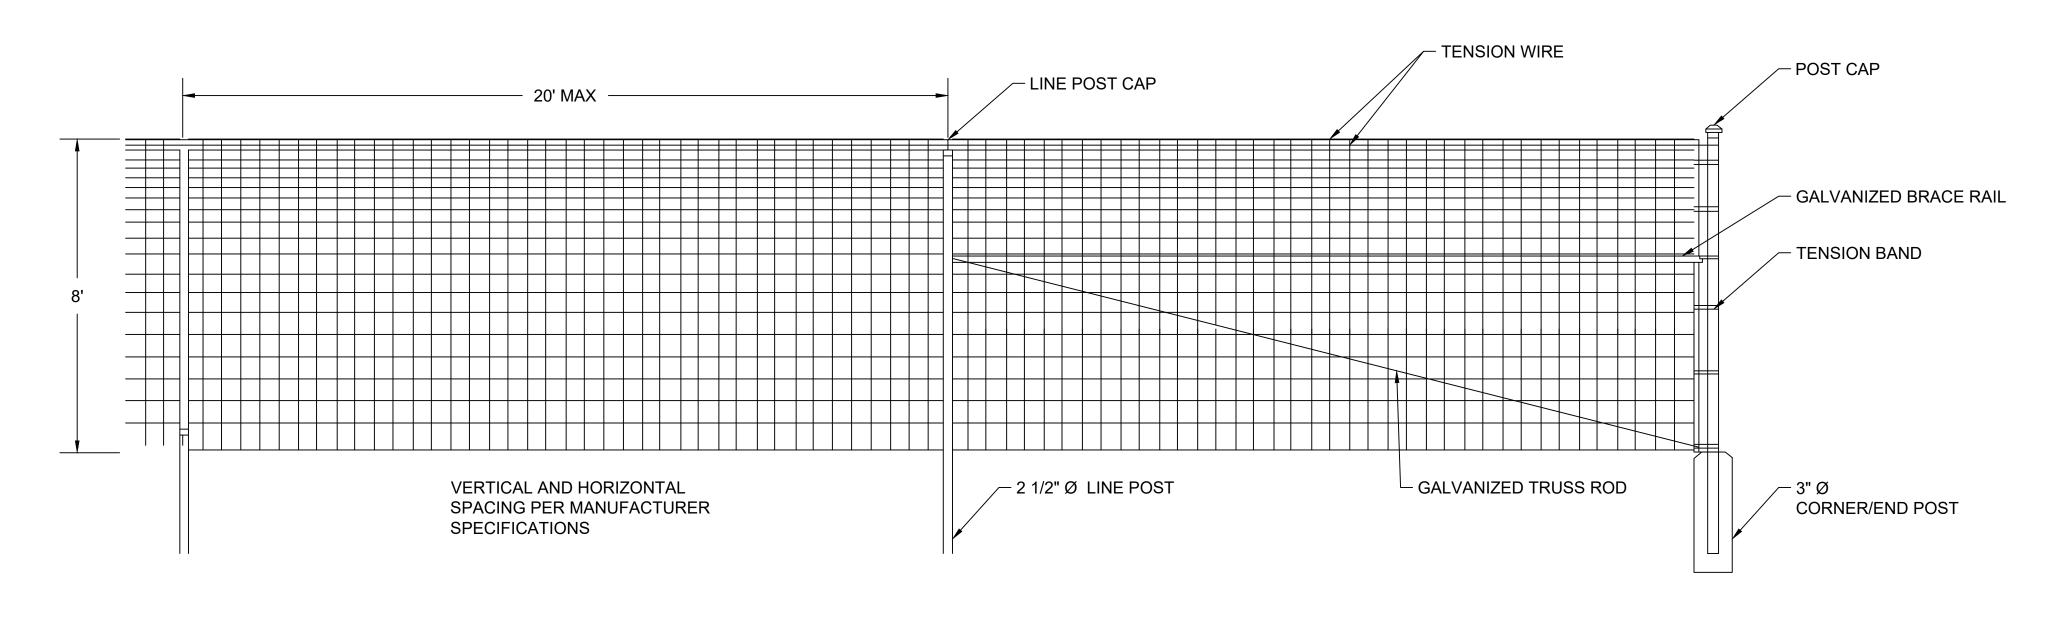

8' FIXED KNOT FENCE NTS

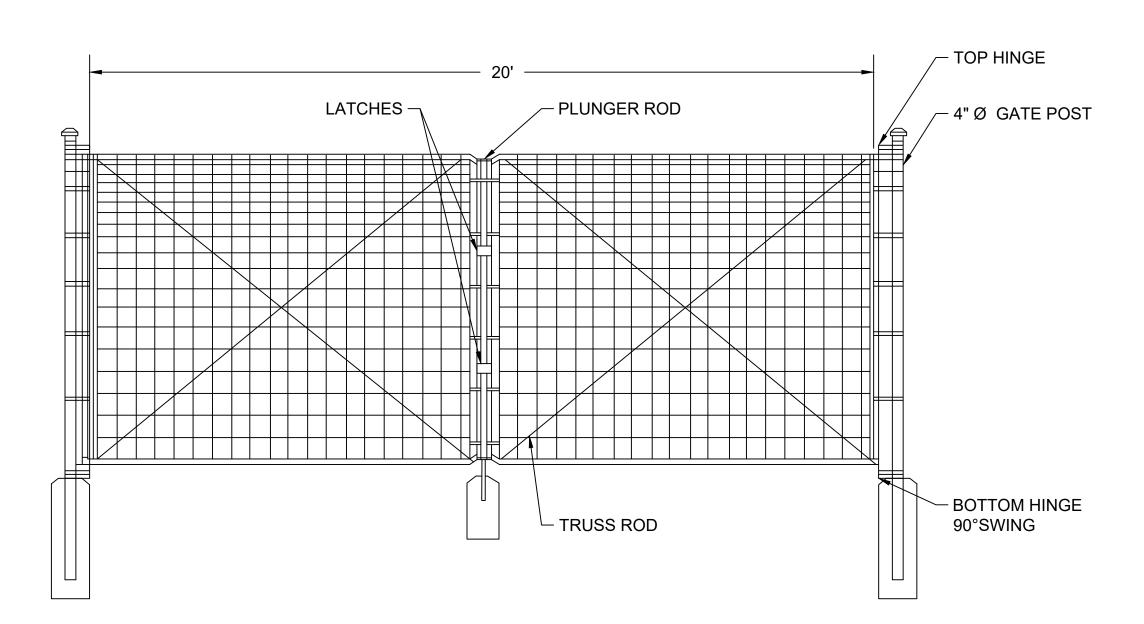

8' FIXED KNOT FENCE GATE

- 1. THIS DRAWING IS FOR INFORMATIONAL PURPOSES ONLY
- AND NOT TO BE USED FOR CONTRUCTION.
- 2. DO NOT SCALE DRAWING



PROJECT ENTITY: WILD CAT SOLAR 4 LLC - SICILIANO

NEW ENERGY EQUITY, LLC 2530 RIVA ROAD, SUITE 200 ANNAPOLIS, MD 21041 NEWENERGYEQUITY.COM 443-267-5012

28964 S PARK AVE BEECHER, IL 60401

LAT: 41.365 LONG: -87.602

SYSTEM SPECIFICATIONS		
SYSTEM SIZE DC	7.378 MW	
SYSTEM SIZE AC	POWER LIMITED TO 5.000 MW	
DC/AC RATIO	1.476	
AZIMUTH	180°	
TILT	+/- 52°	
MODULE COUNT	12720	
MODULE TYPE	HANWHA Q.PEAK DUO XL-G11.3/BFG	
MODULE STC RATING	580 W	
INVERTER COUNT	34	
INVERTER TYPE	SMA SUNNY HIGHPOWER PEAK-: 150kW	
INVERTER POWER	POWER LIMITED TO 147.058 kW	
RACKING	TBD	
MONITORING	ALSO ENERGY	

DESIGN CRITERIA		
MIN/MAX TEMP.	-22°C / 33°C	
WIND SPEED (ASCE 7-10)	105 MPH	
BUILDING CATEGORY	Ţ	
EXPOSURE CATEGORY	С	
GROUND SNOW LOAD	25 PSF	
BUILDING HEIGHT	0'-0"	

OTHER NOTES E-911 ADDRESS TO BE APPLIED FOR WITH BUILDING PERMIT

NO POSITION, DISTANCE, OR CLEARANCE ISSUES WITH OVERHEAD ELECTRIC SERVICE LINES OR OTHER UTILITIES IN RELATION TO THE PV PANELS.

24/7 UNESCORTED KEYLESS ACCESS PROVIDED FOR ALL UTILITY ENERGY EQUIPMENT INCLUDING THE METERS AND AC DISCONNECT.

INTERCONNECTION TYPE: PRIMARY

	REVISIONS		
# DESCRIPTION		BY	DATE
0	ORIGINAL DESIGN	SP	3/20/2023
1	CUP PACKAGE	SP	3/22/2023
2	ACCESS RD CHANGE	SP	4/5/2023
3	1.55 DC/AC RATIO CHANGE	SP	12/7/2023
4	SLD WYE-DELTA WYE	SP	3/14/2024
5	CUP REFRESH	SP	4/30/2024
6	GAS LINE ADDITION	SP	5/9/2024
7	VISUAL SCREENING PAGES	SP	5/28/2024
8			
9			
10			
11			


PROJECT NAME SICILIANO


DRAWING TITLE


FENCE DETAIL

SCALE 1


NTS

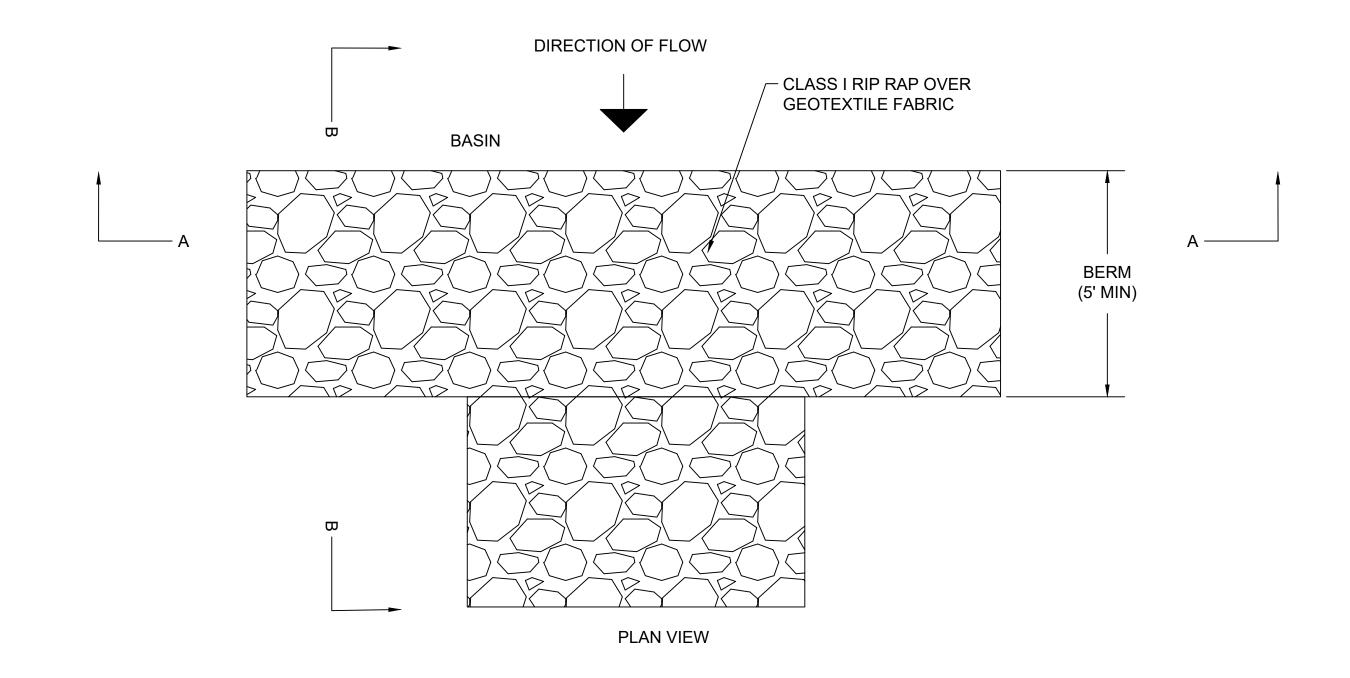

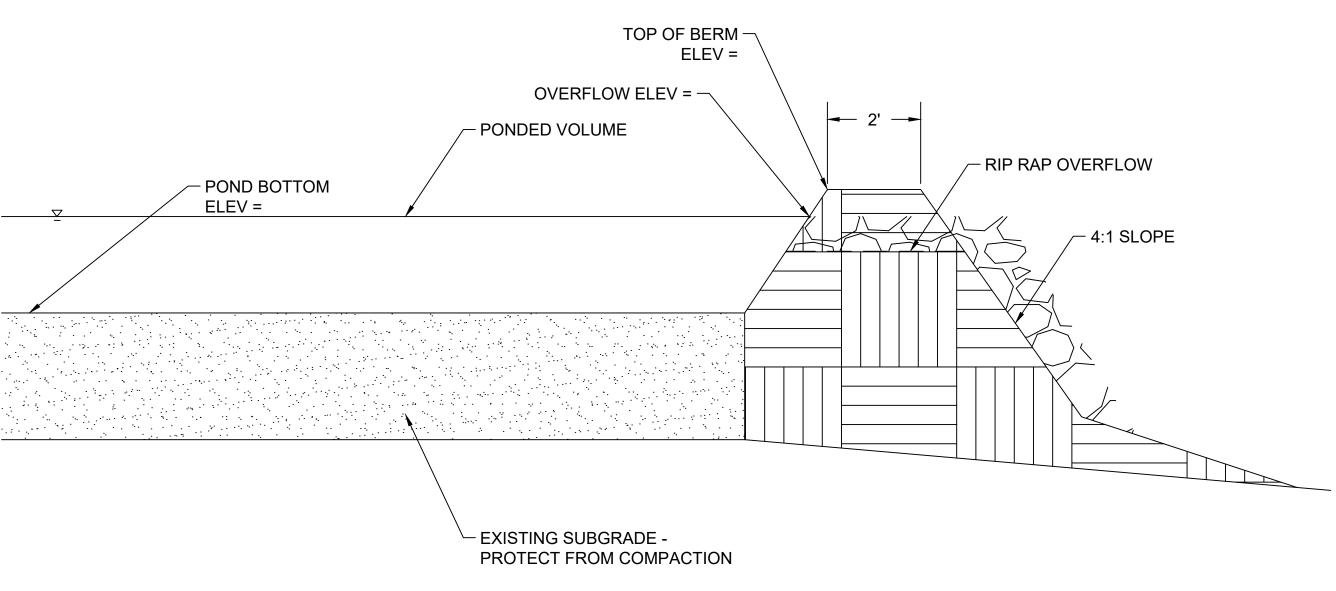

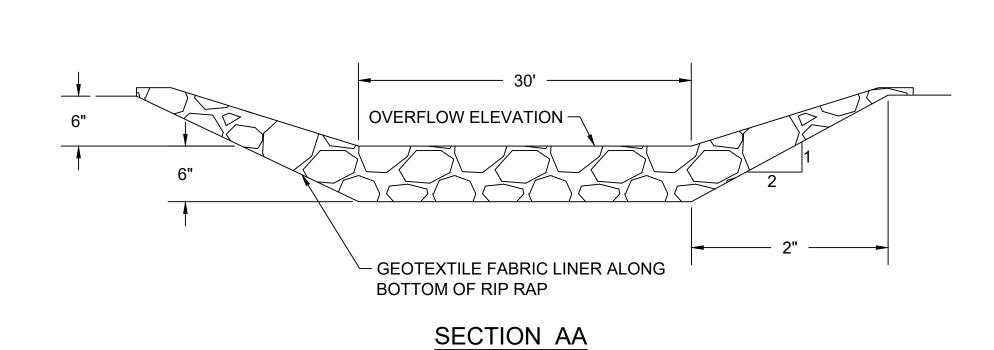



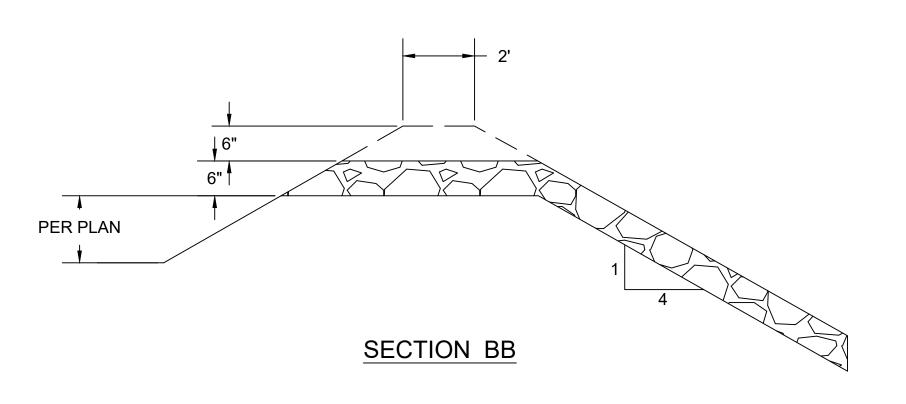

2 RIP RAP OVERFLOW NTS



PROJECT ENTITY: WILD CAT SOLAR 4 LLC - SICILIANO

NEW ENERGY EQUITY, LLC 2530 RIVA ROAD, SUITE 200 ANNAPOLIS, MD 21041 NEWENERGYEQUITY.COM 443-267-5012

PROJECT ADDRESS 28964 S PARK AVE BEECHER, IL 60401

LAT: 41.365 LONG: -87.602

SYSTEM SPECIFICATIONS		
SYSTEM SIZE DC	7.378 MW	
SYSTEM SIZE AC	POWER LIMITED TO 5.000 MW	
DC/AC RATIO	1.476	
AZIMUTH	180°	
TILT	+/- 52°	
MODULE COUNT	12720	
MODULE TYPE	HANWHA Q.PEAK DUO XL-G11.3/BFG	
MODULE STC RATING	580 W	
INVERTER COUNT	34	
INVERTER TYPE	SMA SUNNY HIGHPOWER PEAK-3 150kW	
INVERTER POWER	POWER LIMITED TO 147.058 kW	
RACKING	TBD	
MONITORING	ALSO ENERGY	

DESIGN CRITERIA		
MIN/MAX TEMP.	-22°C / 33°C	
WIND SPEED (ASCE 7-10)	105 MPH	
BUILDING CATEGORY	I	
EXPOSURE CATEGORY	С	
GROUND SNOW LOAD	25 PSF	
BUILDING HEIGHT	0'-0"	

OTHER NOTES
E-911 ADDRESS TO BE APPLIED FOR WITH
BUILDING PERMIT

NO POSITION, DISTANCE, OR CLEARANCE ISSUES WITH OVERHEAD ELECTRIC SERVICE LINES OR OTHER UTILITIES IN RELATION TO THE PV PANELS.

24/7 UNESCORTED KEYLESS ACCESS
PROVIDED FOR ALL UTILITY ENERGY
EQUIPMENT INCLUDING THE METERS AND
AC DISCONNECT.

INTERCONNECTION TYPE: PRIMARY

REVISIONS			
#	DESCRIPTION	BY	DATE
0	ORIGINAL DESIGN	SP	3/20/202
1	CUP PACKAGE	SP	3/22/202
2	ACCESS RD CHANGE	SP	4/5/202
3	1.55 DC/AC RATIO CHANGE	SP	12/7/202
4	SLD WYE-DELTA WYE	SP	3/14/202
5	CUP REFRESH	SP	4/30/202
6	GAS LINE ADDITION	SP	5/9/202
7	VISUAL SCREENING PAGES	SP	5/28/202
8			
9			
10			
11			

PROJECT NAME

SICILIANO

DRAWING TITLE

STORMWATER BASIN DETAIL

SCALE 1

NTS

SHEET

PV9




PLANTING SCHEDULE

TYPE: BLACK HILLS SPRUCE


HEIGHT: 6' MIN WITHIN 3 YEARS OF PLANTING


NUMBER OF ROWS: 2 SPACING: 16' O.C.

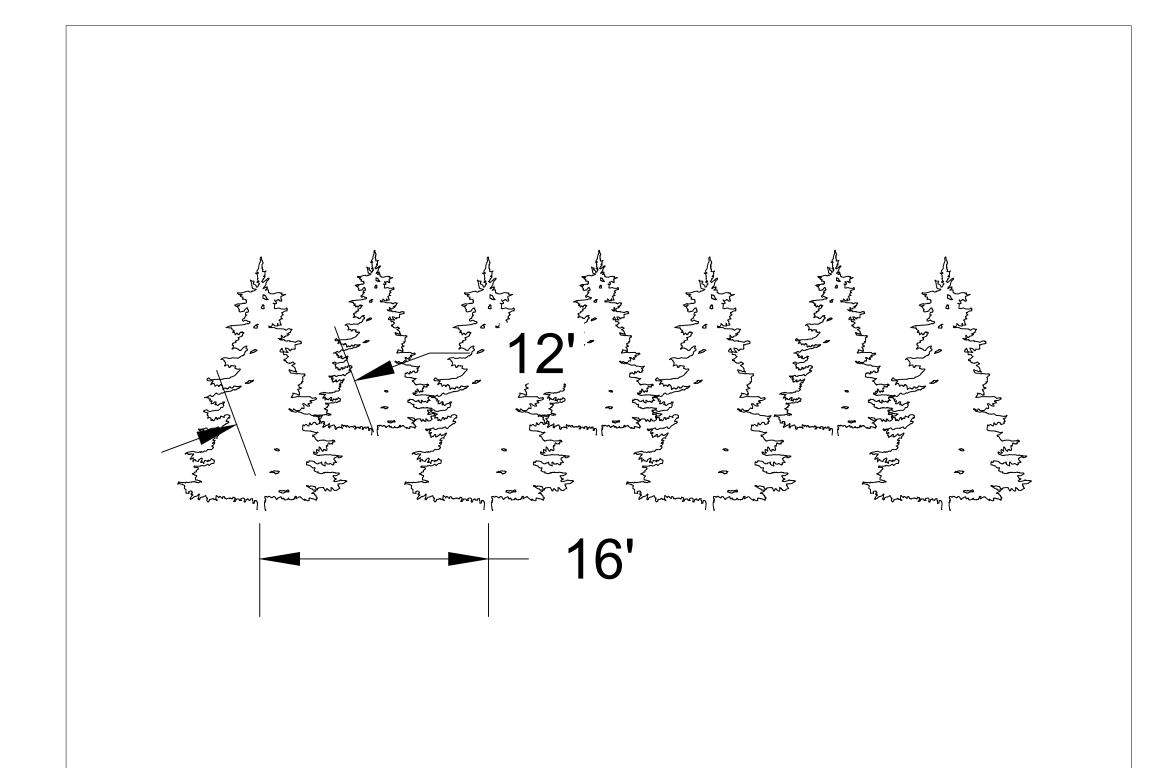

BLACK HILLS SPRUCE SCREENING

Scale: N.T.S.

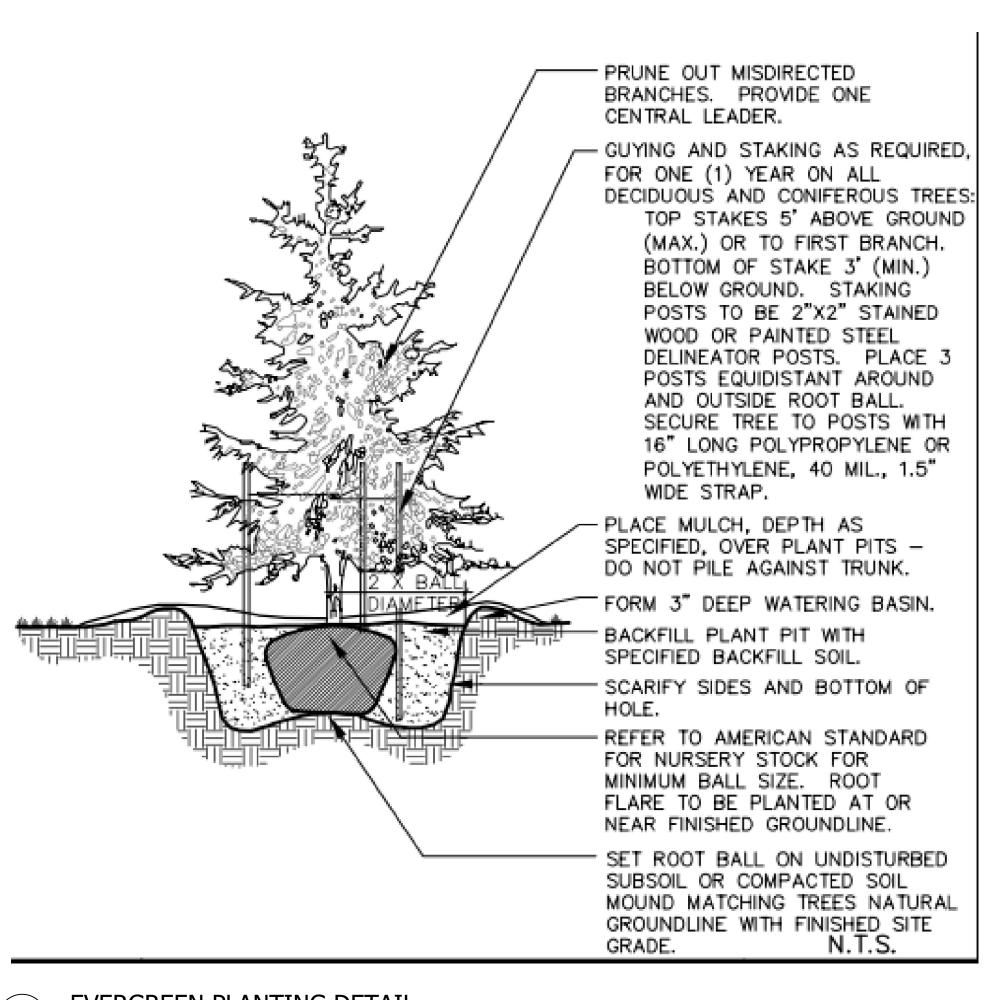

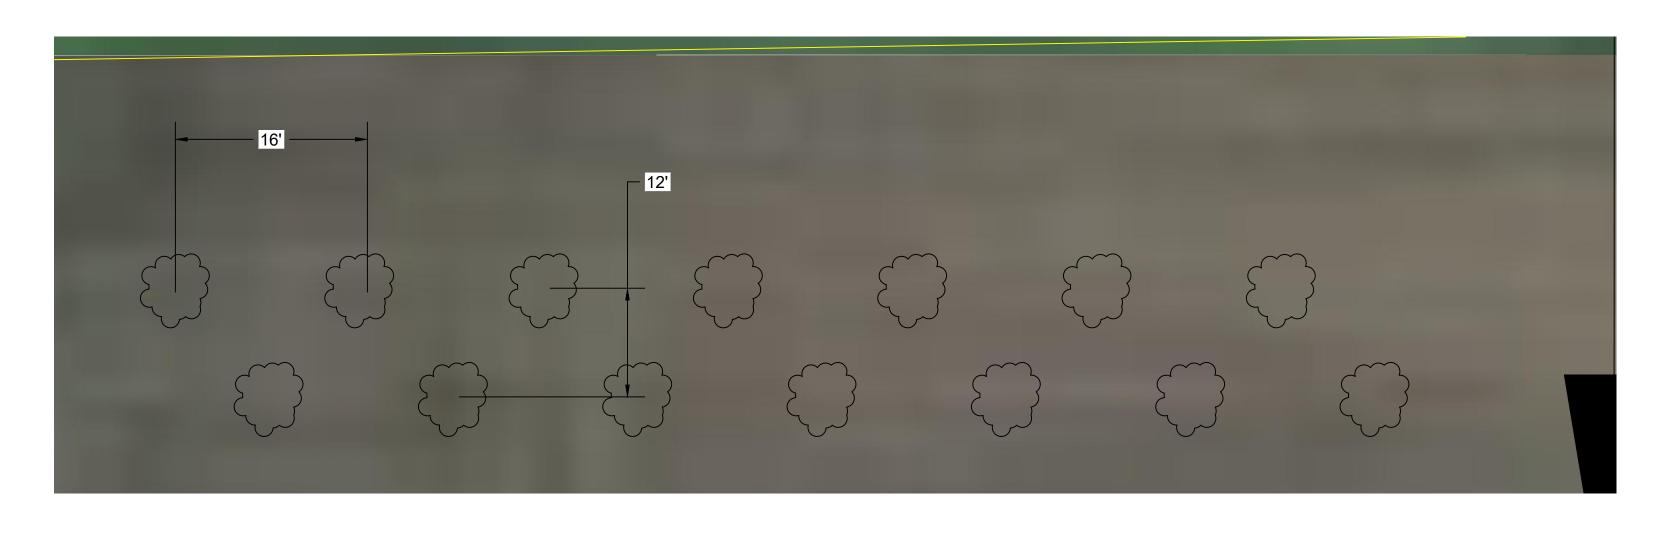

1" = 8'

3 PLAN VIEW

EVERGREEN PLANTING DETAIL

Scale: N.T.S.



PROJECT ENTITY: WILD CAT SOLAR 4 LLC - SICILIANO

NEW ENERGY EQUITY, LLC 2530 RIVA ROAD, SUITE 200 ANNAPOLIS, MD 21041 NEWENERGYEQUITY.COM 443-267-5012

PROJECT ADDRESS 28964 S PARK AVE BEECHER, IL 60401

LAT: 41.365 LONG: -87.602

SYSTEM	SPECIFICATIONS
SYSTEM SIZE DC	7.378 MW
SYSTEM SIZE AC	POWER LIMITED TO 5.000 MW
DC/AC RATIO	1.476
AZIMUTH	180°
TILT	+/- 52°
MODULE COUNT	12720
MODULE TYPE	HANWHA Q.PEAK DUO XL-G11.3/BFG
MODULE STC RATING	580 W
INVERTER COUNT	34
INVERTER TYPE	SMA SUNNY HIGHPOWER PEAK 150kW
INVERTER POWER	POWER LIMITED TO 147.058 kV
RACKING	TBD
MONITORING	ALSO ENERGY

DESIGN CRITERIA		
MIN/MAX TEMP.	-22°C / 33°C	
WIND SPEED (ASCE 7-10)	105 MPH	
BUILDING CATEGORY	I	
EXPOSURE CATEGORY	С	
GROUND SNOW LOAD	25 PSF	
BUILDING HEIGHT	0'-0"	
	MIN/MAX TEMP. WIND SPEED (ASCE 7-10) BUILDING CATEGORY EXPOSURE CATEGORY GROUND SNOW LOAD	

OTHER NOTES
E-911 ADDRESS TO BE APPLIED FOR WITH
BUILDING PERMIT

NO POSITION, DISTANCE, OR CLEARANCE ISSUES WITH OVERHEAD ELECTRIC SERVICE LINES OR OTHER UTILITIES IN RELATION TO THE PV PANELS.

24/7 UNESCORTED KEYLESS ACCESS PROVIDED FOR ALL UTILITY ENERGY EQUIPMENT INCLUDING THE METERS AND AC DISCONNECT.

INTERCONNECTION TYPE: PRIMARY

	REVISIONS		
#	DESCRIPTION	BY	DATE
0	ORIGINAL DESIGN	SP	3/20/2023
1	CUP PACKAGE	SP	3/22/2023
2	ACCESS RD CHANGE	SP	4/5/2023
3	1.55 DC/AC RATIO CHANGE	SP	12/7/2023
4	SLD WYE-DELTA WYE	SP	3/14/2024
5	CUP REFRESH	SP	4/30/2024
6	GAS LINE ADDITION	SP	5/9/2024
7	VISUAL SCREENING PAGES	SP	5/28/2024
8			
9			
10			
11			

PROJECT NAME
SICILIANO

DRAWING TITLE


SCREENING PLAN

SCALE 1

NTS

SHEET

PV10

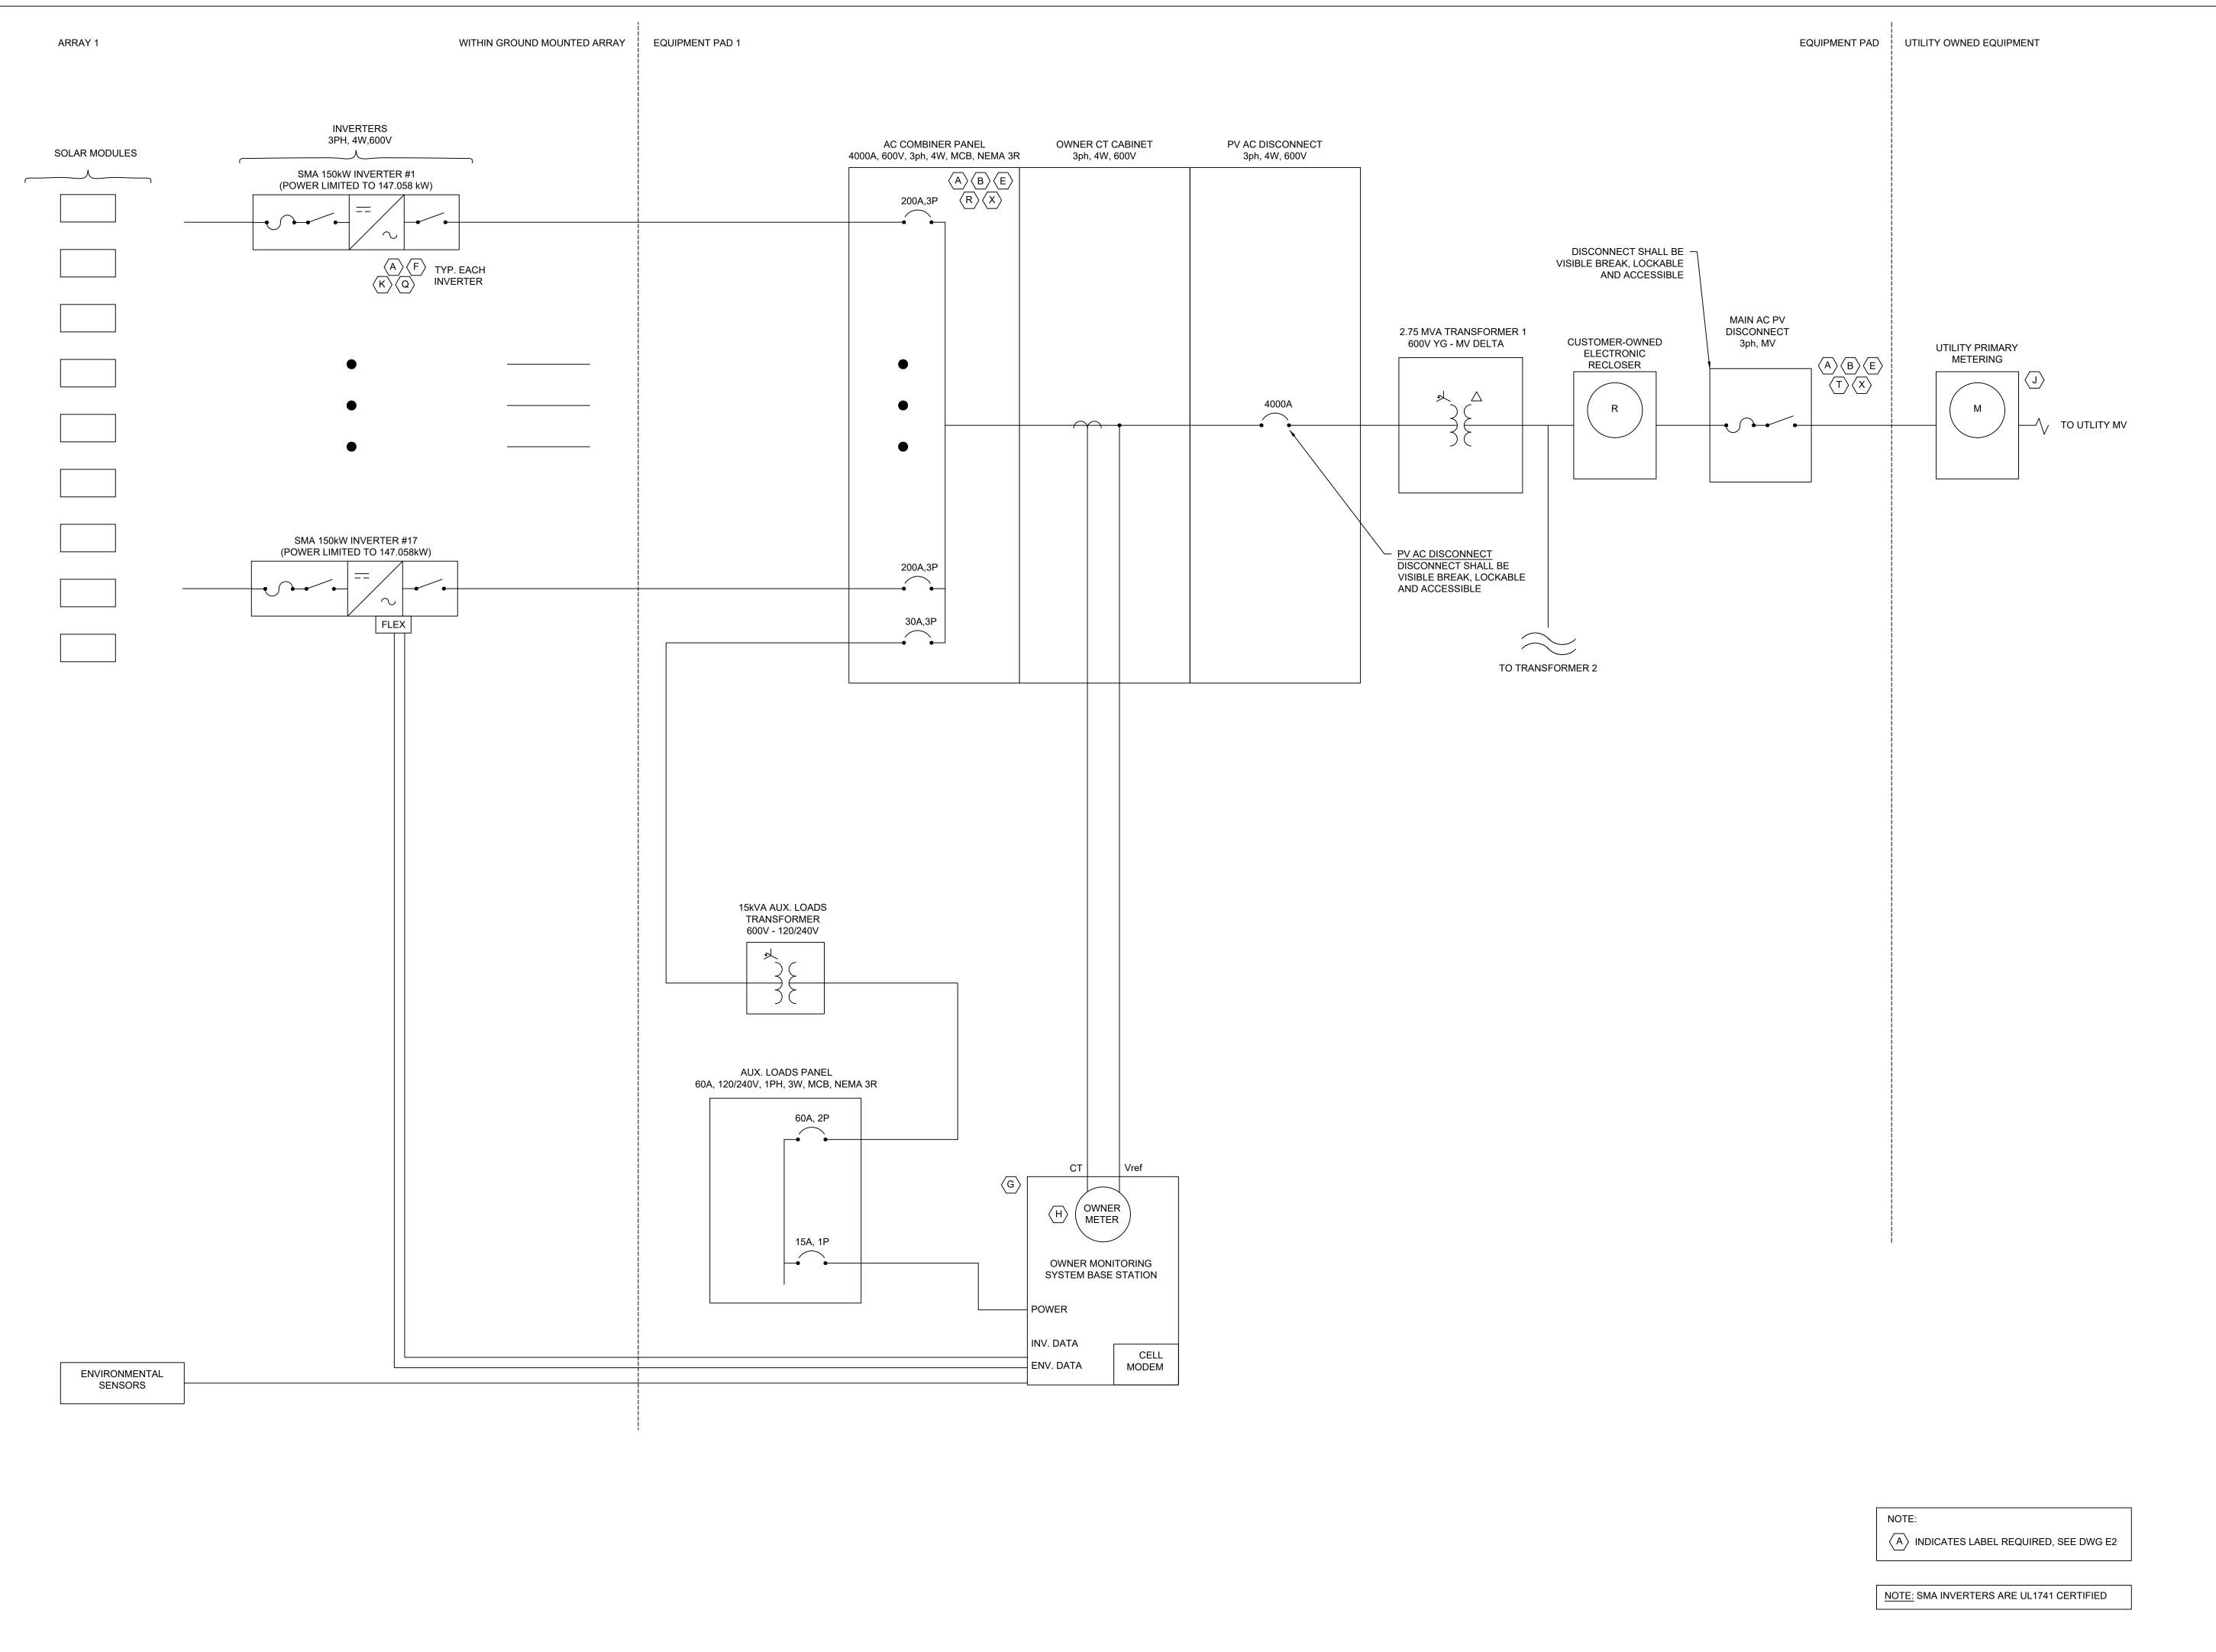



NEW ENERGY EQUITY, LLC 2530 RIVA ROAD, SUITE 200 ANNAPOLIS, MD 21041 NEWENERGYEQUITY.COM 443-267-5012

PROJECT ADDRESS 28964 S PARK AVE BEECHER, IL 60401

LAT: 41.365 LONG: -87.602

SYSTEM	SPECIFICATIONS
SYSTEM SIZE DC 7.378 MW	
SYSTEM SIZE AC	POWER LIMITED TO 5.000 MW
DC/AC RATIO	1.476
AZIMUTH	180°
TILT	+/- 52°
MODULE COUNT	12720
MODULE TYPE	HANWHA Q.PEAK DUO XL-G11.3/BFG
MODULE STC RATING	580 W
INVERTER COUNT	34
INVERTER TYPE	SMA SUNNY HIGHPOWER PEAK- 150kW
INVERTER POWER	POWER LIMITED TO 147.058 kW
RACKING	TBD
MONITORING	ALSO ENERGY

DESIGN CRITERIA		
MIN/MAX TEMP.	-22°C / 33°C	
WIND SPEED (ASCE 7-10)	105 MPH	
BUILDING CATEGORY	I	
EXPOSURE CATEGORY	С	
GROUND SNOW LOAD	25 PSF	
BUILDING HEIGHT	0'-0"	

OTHER NOTES
E-911 ADDRESS TO BE APPLIED FOR WITH
BUILDING PERMIT

NO POSITION, DISTANCE, OR CLEARANCE ISSUES WITH OVERHEAD ELECTRIC SERVICE LINES OR OTHER UTILITIES IN RELATION TO THE PV PANELS.

24/7 UNESCORTED KEYLESS ACCESS
PROVIDED FOR ALL UTILITY ENERGY
EQUIPMENT INCLUDING THE METERS AND
AC DISCONNECT.

INTERCONNECTION TYPE: PRIMARY

	REVISIONS		
#	DESCRIPTION	BY	DATE
0	ORIGINAL DESIGN	SP	3/20/202
1	CUP PACKAGE	SP	3/22/202
2	ACCESS RD CHANGE	SP	4/5/202
3	1.55 DC/AC RATIO CHANGE	SP	12/7/202
4	SLD WYE-DELTA WYE	SP	3/14/202
5	CUP REFRESH	SP	4/30/202
6	GAS LINE ADDITION	SP	5/9/2024
7	VISUAL SCREENING PAGES	SP	5/28/202
8			
9			
10			
11			

PROJECT NAME

SICILIANO

DRAWING TITLE


SINGLE LINE

SCALE 1

NTS

SHEET

E1A

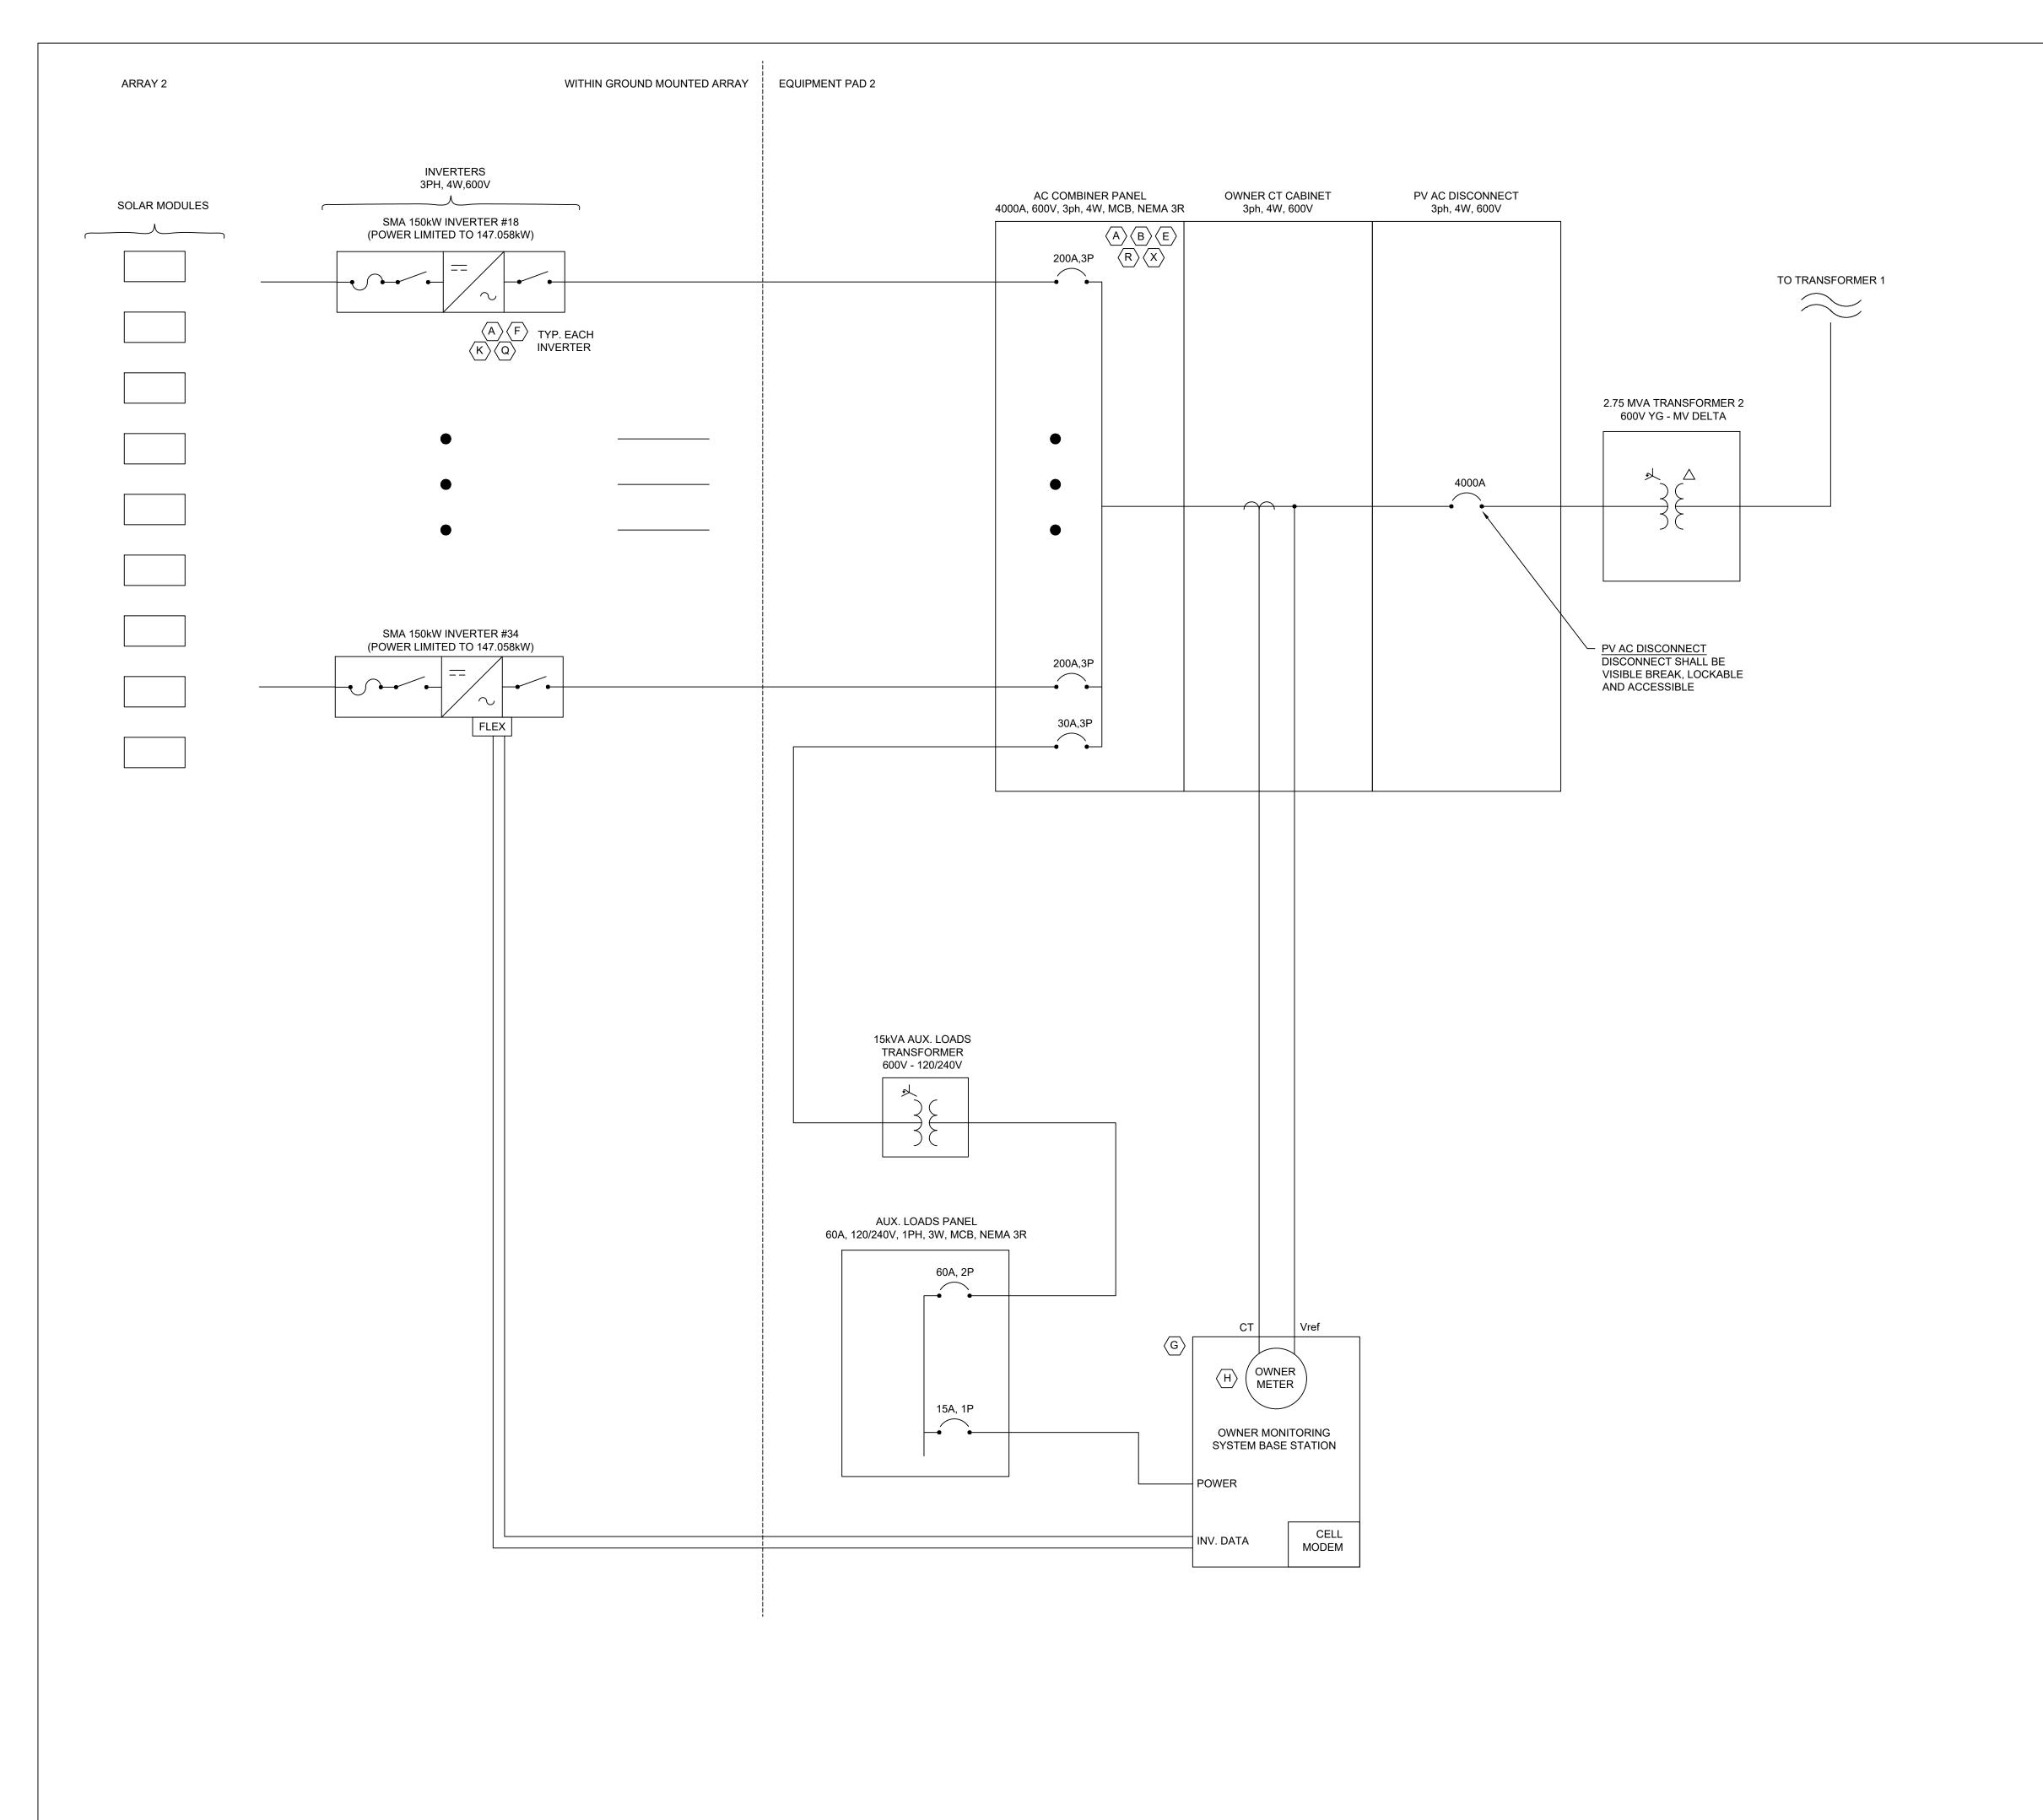



NOTE: SMA INVERTERS ARE UL1741 CERTIFIED



PROJECT ENTITY: WILD CAT SOLAR 4 LLC - SICILIANO

NEW ENERGY EQUITY, LLC 2530 RIVA ROAD, SUITE 200 ANNAPOLIS, MD 21041 NEWENERGYEQUITY.COM 443-267-5012

PROJECT ADDRESS 28964 S PARK AVE

LAT: 41.365 LONG: -87.602 BEECHER, IL 60401

SYSTEM SPECIFICATIONS		
SYSTEM SIZE DC 7.378 MW		
SYSTEM SIZE AC	POWER LIMITED TO 5.000 MW	
DC/AC RATIO	1.476	
AZIMUTH	180°	
TILT	+/- 52°	
MODULE COUNT	12720	
MODULE TYPE	HANWHA Q.PEAK DUO XL-G11.3/BFG	
MODULE STC RATING	580 W	
INVERTER COUNT	34	
INVERTER TYPE	SMA SUNNY HIGHPOWER PEAK-: 150kW	
INVERTER POWER	POWER LIMITED TO 147.058 kW	
RACKING	TBD	
MONITORING	ALSO ENERGY	

DESIGN CRITERIA		
MIN/MAX TEMP.	-22°C / 33°C	
WIND SPEED (ASCE 7-10)	105 MPH	
BUILDING CATEGORY	I	
EXPOSURE CATEGORY	С	
GROUND SNOW LOAD	25 PSF	
BUILDING HEIGHT	0'-0"	

OTHER NOTES E-911 ADDRESS TO BE APPLIED FOR WITH BUILDING PERMIT

NO POSITION, DISTANCE, OR CLEARANCE ISSUES WITH OVERHEAD ELECTRIC SERVICE LINES OR OTHER UTILITIES IN RELATION TO THE PV PANELS.

24/7 UNESCORTED KEYLESS ACCESS PROVIDED FOR ALL UTILITY ENERGY EQUIPMENT INCLUDING THE METERS AND AC DISCONNECT.

INTERCONNECTION TYPE: PRIMARY

	REVISIONS		
#	DESCRIPTION	BY	DATE
0	ORIGINAL DESIGN	SP	3/20/2023
1	CUP PACKAGE	SP	3/22/2023
2	ACCESS RD CHANGE	SP	4/5/2023
3	1.55 DC/AC RATIO CHANGE	SP	12/7/2023
4	SLD WYE-DELTA WYE	SP	3/14/2024
5	CUP REFRESH	SP	4/30/2024
6	GAS LINE ADDITION	SP	5/9/2024
7	VISUAL SCREENING PAGES	SP	5/28/2024
8			
9			
10			
11			

PROJECT NAME


SICILIANO


DRAWING TITLE


SINGLE LINE

SCALE 1

SHEET

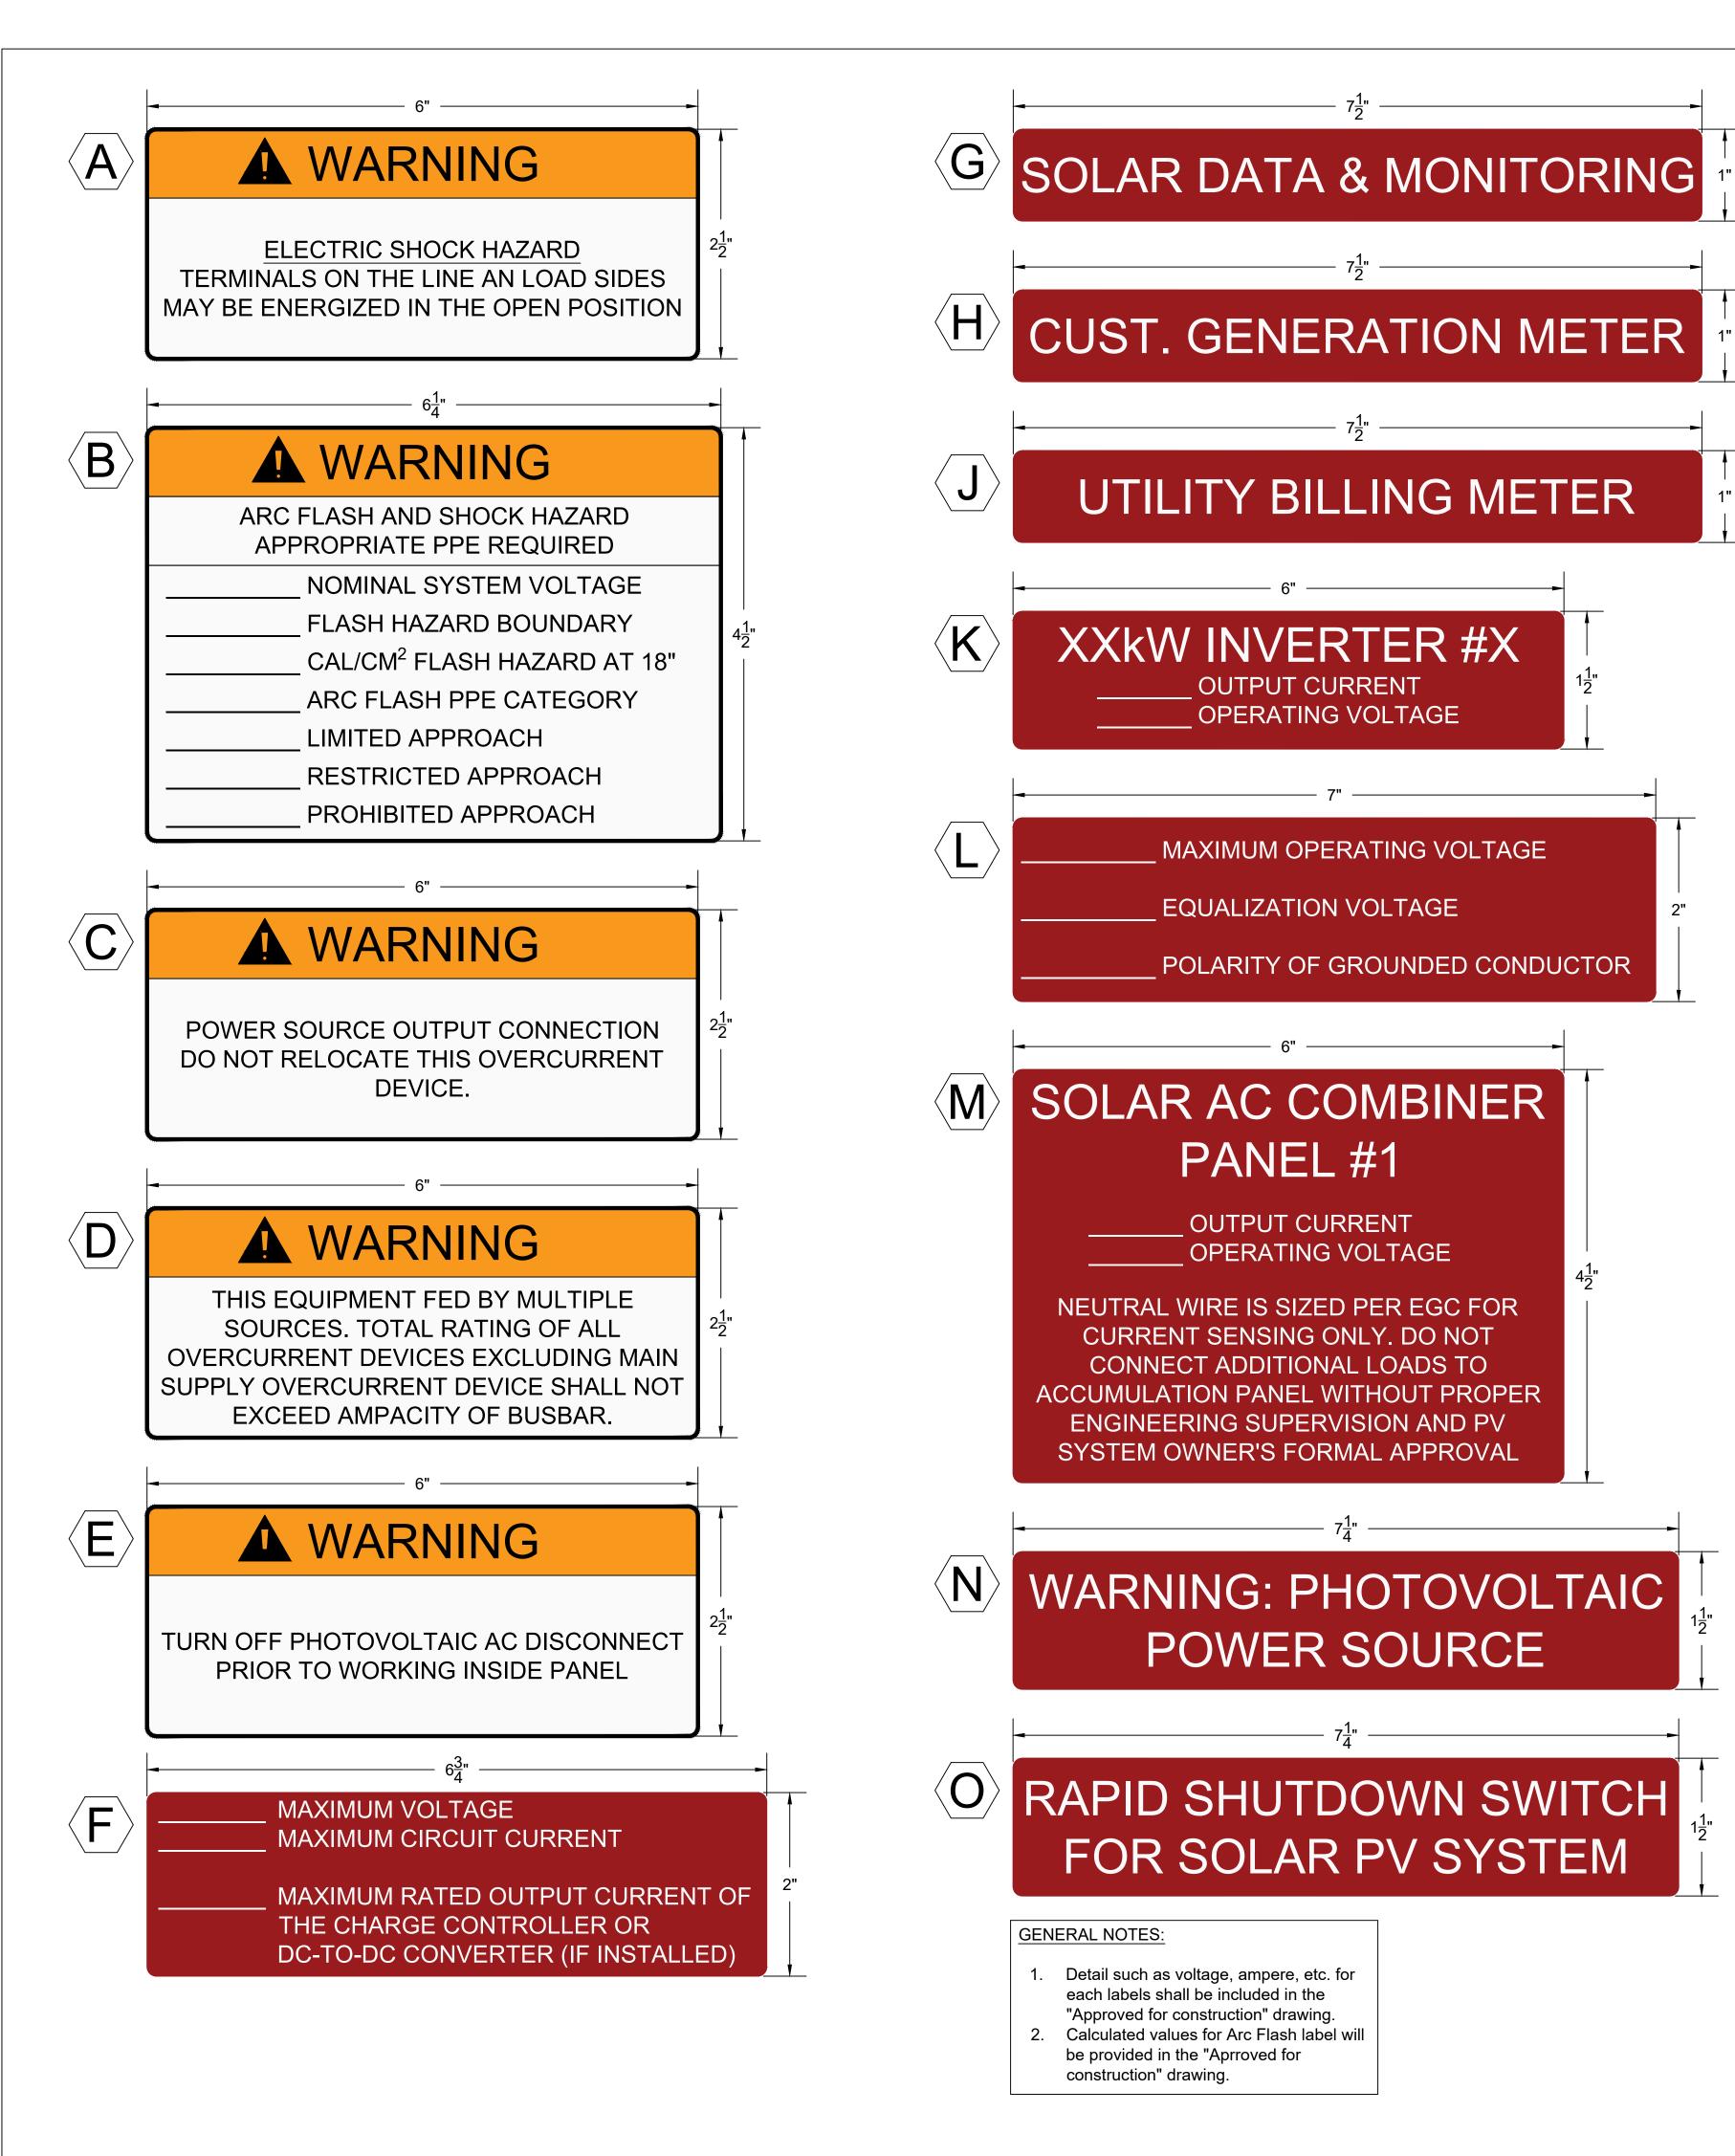

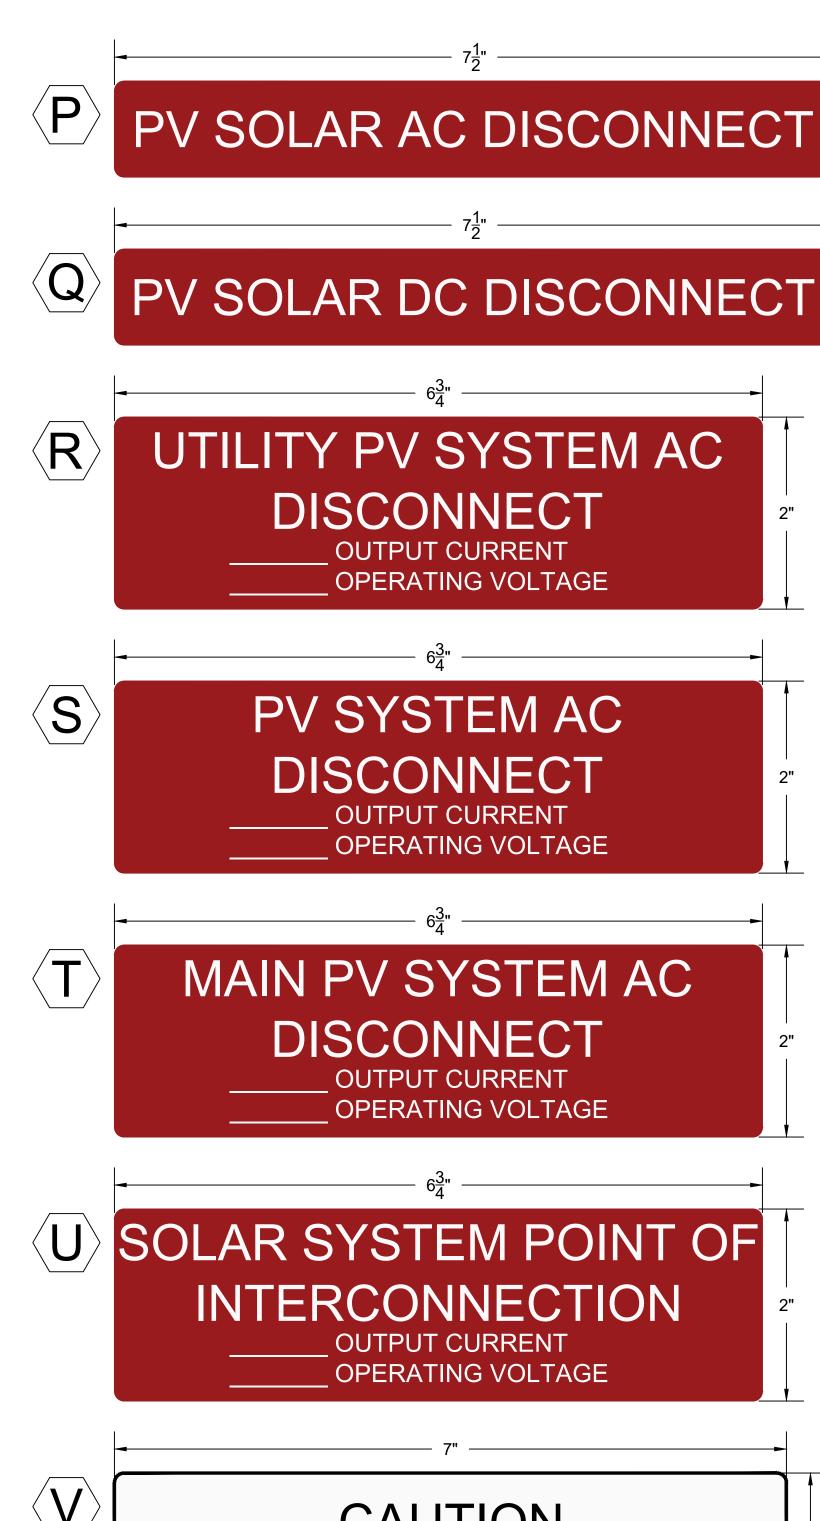

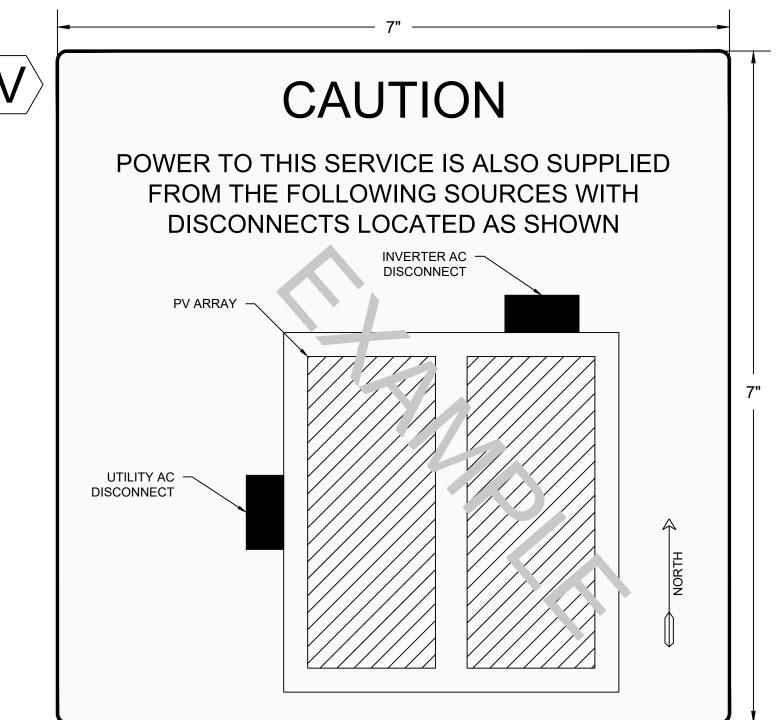



NEW ENERGY EQUITY, LLC 2530 RIVA ROAD, SUITE 200 ANNAPOLIS, MD 21041 NEWENERGYEQUITY.COM 443-267-5012

PROJECT ADDRESS 28964 S PARK AVE BEECHER, IL 60401

LAT: 41.365 LONG: -87.602

SYSTEM	SPECIFICATIONS
SYSTEM SIZE DC	7.378 MW
SYSTEM SIZE AC	POWER LIMITED TO 5.000 MV
DC/AC RATIO	1.476
AZIMUTH	180°
TILT	+/- 52°
MODULE COUNT	12720
MODULE TYPE	HANWHA Q.PEAK DUO XL-G11.3/BFG
MODULE STC RATING	580 W
INVERTER COUNT	34
INVERTER TYPE	SMA SUNNY HIGHPOWER PEA 150kW
INVERTER POWER	POWER LIMITED TO 147.058 k
RACKING	TBD
MONITORING	ALSO ENERGY

	DESIGN CRITERIA		
ľ	MIN/MAX TEMP.	-22°C / 33°C	
	WIND SPEED (ASCE 7-10)	105 MPH	
	BUILDING CATEGORY	I	
	EXPOSURE CATEGORY	С	
	GROUND SNOW LOAD	25 PSF	
	BUILDING HEIGHT	0'-0"	

OTHER NOTES
E-911 ADDRESS TO BE APPLIED FOR WITH
BUILDING PERMIT

NO POSITION, DISTANCE, OR CLEARANCE ISSUES WITH OVERHEAD ELECTRIC SERVICE LINES OR OTHER UTILITIES IN RELATION TO THE PV PANELS.

24/7 UNESCORTED KEYLESS ACCESS PROVIDED FOR ALL UTILITY ENERGY EQUIPMENT INCLUDING THE METERS AND AC DISCONNECT.

INTERCONNECTION TYPE: PRIMARY

REVISIONS					
#	DESCRIPTION	BY	DATE		
0	ORIGINAL DESIGN	SP	3/20/2023		
1	CUP PACKAGE	SP	3/22/2023		
2	ACCESS RD CHANGE	SP	4/5/2023		
3	1.55 DC/AC RATIO CHANGE	SP	12/7/2023		
4	SLD WYE-DELTA WYE	SP	3/14/2024		
5	CUP REFRESH	SP	4/30/2024		
6	GAS LINE ADDITION	SP	5/9/2024		
7	VISUAL SCREENING PAGES	SP	5/28/2024		
8					
9					
10					
11					

PROJECT NAME
SICILIANO

DRAWING TITLE


SYSTEM LABELS A

SCALE 1

NITS

SHEET

E2A

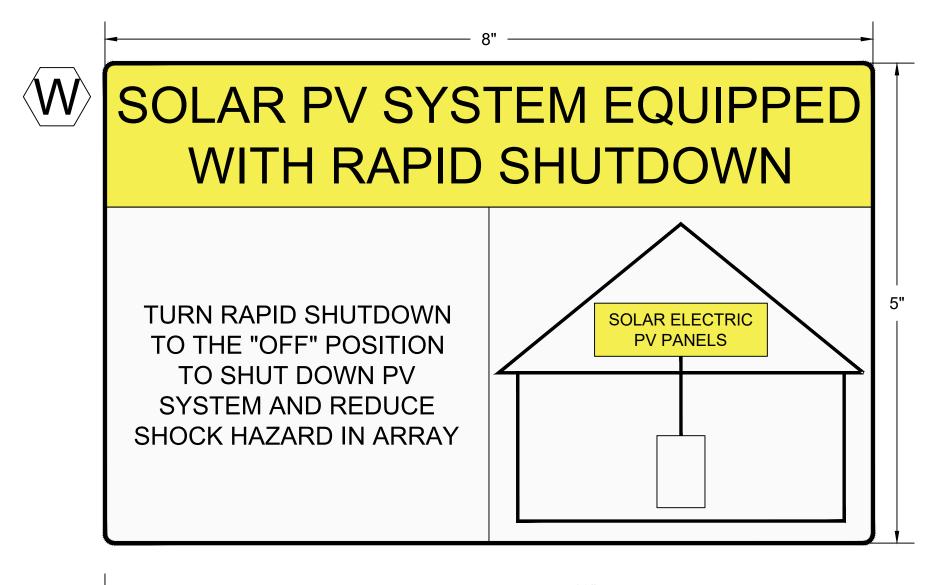

MARNING DUAL POWER SOURCE

SECOND SOURCE IS PV SYSTEM



GENERAL NOTES:

- (1) ALL LABELS MUST COMPLY WITH 2020 NEC 110.21(B):
- (2) LABELS AS PROVIDED AND NOTED ON THIS SHEET MEET WARNING, EFFECTIVE WORDING AND COLOR/SYMBOL REQUIREMENTS
- (3) LABELS SHALL BE PERMANENTLY AFFIXED TO EQUIPMENT OR WIRING METHOD
- (4) LABELS SHALL BE OF SUFFICIENT DURABILITY TO WITHSTAND THE ENVIRONMENT INVOLVED. STICKERS OF PROPER DURABILITY AND ADHESION ARE PREFERRED. REFERENCE ANSI Z535.4-2011 FOR GUIDELINES.

SPECIFIC LABEL NOTES:

- A. 2020 NEC 690.13(D)
- B. 2020 NEC 110.16
- C. 2020 NEC 705.12(B)(1)(b)
- D. 2020 NEC 110.27(C)
- E. 2020 NEC 110.27(C)
- F. 2020 NEC 690.53
- G. UTILITY REQUIREMENT
- H. UTILITY REQUIREMENT
- I. LABEL REMOVED
- J. UTILITY REQUIREMENT
- K. 2020 NEC 690.54
- L. 2020 NEC 690.55
- M. LABEL FOR ACCUMULATION PANEL
- N. 2020 NEC 690.31(F)
- O. 2020 NEC 690.56(C)
- P. 2020 NEC 690.13(B)
- Q. 2020 NEC 690.13(B)
- R. 2020 NEC 690.54S. 2020 NEC 690.54
- 3. 2020 NEC 090.34
- T. 2020 NEC 690.13(B)
- U. LABEL FOR POINT OF INTERCONNECTION
- V. 2020 NEC 705.10 SYSTEM PLACCARD
- W. 2020 NEC 690.56(C)(1)
- X. 2020 NEC 690.59

EQUIPMENT	LABELS
ACCUMULATION PANELS, COMBINER BOXES, PULL BOXES, ENCLOSURES	A, B, E, M
DC CONDUIT	N
RAPID SHUTDOWN	O, W
ENERGY STORAGE	L
INVERTERS	K
MONITORING EQUIPMENT	G
METERS	H, J, X
DC DISCONNECT	A, F, Q
AC DISCONNECT	A, B, E, O, P, R, S, T, X
POINT OF INTERCONNECTION	A, C, D, U, V, E



PROJECT ENTITY: WILD CAT SOLAR 4 LLC - SICILIANO

NEW ENERGY EQUITY, LLC 2530 RIVA ROAD, SUITE 200 ANNAPOLIS, MD 21041 NEWENERGYEQUITY.COM 443-267-5012

PROJECT ADDRESS 28964 S PARK AVE BEECHER, IL 60401

LAT: 41.365 LONG: -87.602

SYSTEM SPECIFICATIONS				
SYSTEM SIZE DC 7.378 MW				
SYSTEM SIZE AC	POWER LIMITED TO 5.000 MW			
DC/AC RATIO	1.476			
AZIMUTH	180°			
TILT	+/- 52°			
MODULE COUNT	12720			
MODULE TYPE	HANWHA Q.PEAK DUO XL-G11.3/BFG			
MODULE STC RATING	580 W			
INVERTER COUNT	34			
INVERTER TYPE	SMA SUNNY HIGHPOWER PEAK- 150kW			
INVERTER POWER	POWER LIMITED TO 147.058 kW			
RACKING	TBD			
MONITORING	ALSO ENERGY			

	DESIGN CRITERIA				
	MIN/MAX TEMP22°C / 33°C				
	WIND SPEED (ASCE 7-10)	105 MPH			
	BUILDING CATEGORY	I			
	EXPOSURE CATEGORY	С			
	GROUND SNOW LOAD	25 PSF			
	BUILDING HEIGHT	0'-0"			
\bigcup_{i}	·	<u> </u>			

OTHER NOTES
E-911 ADDRESS TO BE APPLIED FOR WITH
BUILDING PERMIT

NO POSITION, DISTANCE, OR CLEARANCE ISSUES WITH OVERHEAD ELECTRIC SERVICE LINES OR OTHER UTILITIES IN RELATION TO THE PV PANELS.

24/7 UNESCORTED KEYLESS ACCESS PROVIDED FOR ALL UTILITY ENERGY EQUIPMENT INCLUDING THE METERS AND AC DISCONNECT.

INTERCONNECTION TYPE: PRIMARY

REVISIONS			
#	DESCRIPTION	BY	DATE
0	ORIGINAL DESIGN	SP	3/20/20
1	CUP PACKAGE	SP	3/22/20
2	ACCESS RD CHANGE	SP	4/5/202
3	1.55 DC/AC RATIO CHANGE	SP	12/7/20
4	SLD WYE-DELTA WYE	SP	3/14/20
5	CUP REFRESH	SP	4/30/20
6	GAS LINE ADDITION	SP	5/9/202
7	VISUAL SCREENING PAGES	SP	5/28/20
8			
9			
10			
11			

PROJECT NAME

SICILIANO


DRAWING TITLE

SYSTEM LABELS B

SCALE 1

SHEE

E2B

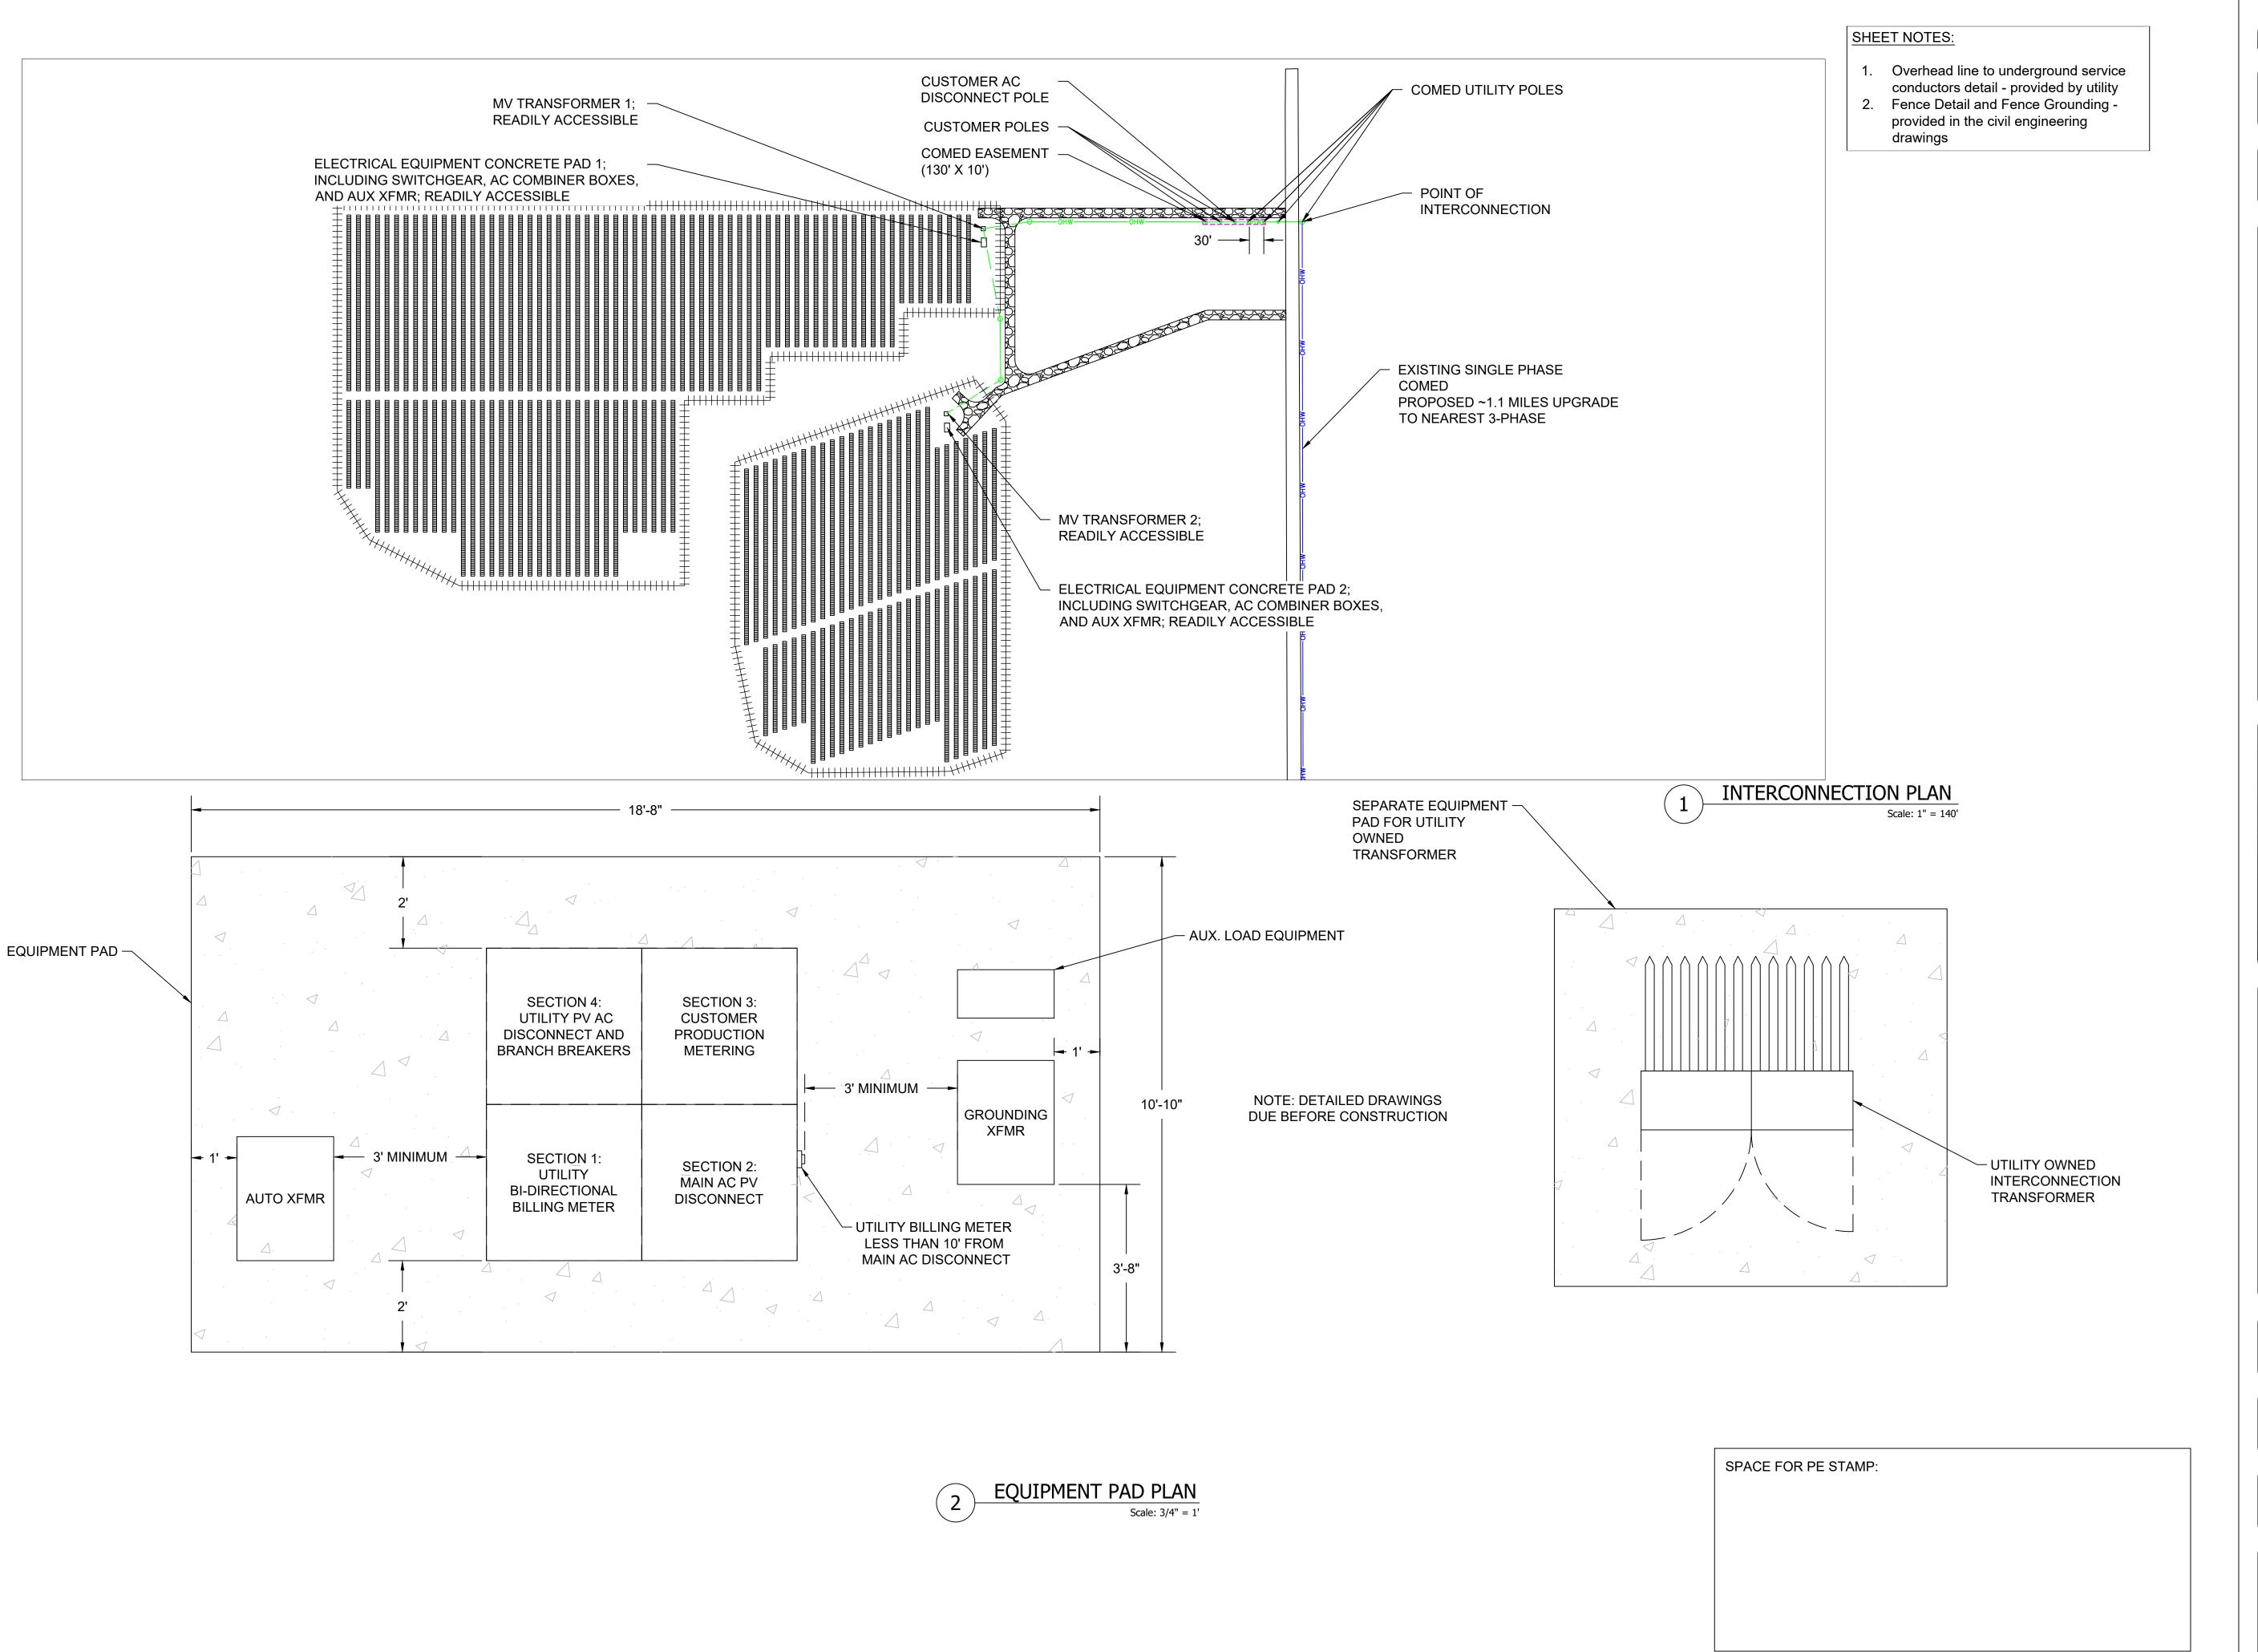



NEW ENERGY EQUITY, LLC 2530 RIVA ROAD, SUITE 200 ANNAPOLIS, MD 21041 NEWENERGYEQUITY.COM 443-267-5012

PROJECT ADDRESS 28964 S PARK AVE

LAT: 41.365 LONG: -87.602 BEECHER, IL 60401

SYSTEM SPECIFICATIONS			
SYSTEM SIZE DC 7.378 MW			
SYSTEM SIZE AC	POWER LIMITED TO 5.000 MW		
DC/AC RATIO	1.476		
AZIMUTH	180°		
TILT	+/- 52°		
MODULE COUNT	12720		
MODULE TYPE	HANWHA Q.PEAK DUO XL-G11.3/BFG		
MODULE STC RATING	580 W		
INVERTER COUNT	34		
INVERTER TYPE	SMA SUNNY HIGHPOWER PEAK- 150kW		
INVERTER POWER	POWER LIMITED TO 147.058 kW		
RACKING	TBD		
MONITORING	ALSO ENERGY		

DESIGN CRITERIA			
MIN/MAX TEMP22°C / 33°C			
WIND SPEED (ASCE 7-10)	105 MPH		
BUILDING CATEGORY	I		
EXPOSURE CATEGORY	С		
GROUND SNOW LOAD	25 PSF		
BUILDING HEIGHT	0'-0"		
	MIN/MAX TEMP. WIND SPEED (ASCE 7-10) BUILDING CATEGORY EXPOSURE CATEGORY GROUND SNOW LOAD		

OTHER NOTES E-911 ADDRESS TO BE APPLIED FOR WITH **BUILDING PERMIT**

NO POSITION, DISTANCE, OR CLEARANCE ISSUES WITH OVERHEAD ELECTRIC SERVICE LINES OR OTHER UTILITIES IN RELATION TO THE PV PANELS.

24/7 UNESCORTED KEYLESS ACCESS PROVIDED FOR ALL UTILITY ENERGY EQUIPMENT INCLUDING THE METERS AND AC DISCONNECT.

INTERCONNECTION TYPE: PRIMARY

REVISIONS			
#	DESCRIPTION	BY	DATI
0	ORIGINAL DESIGN	SP	3/20/20
1	CUP PACKAGE	SP	3/22/20
2	ACCESS RD CHANGE	SP	4/5/20
3	1.55 DC/AC RATIO CHANGE	SP	12/7/20
4	SLD WYE-DELTA WYE	SP	3/14/20
5	CUP REFRESH	SP	4/30/20
6	GAS LINE ADDITION	SP	5/9/20
7	VISUAL SCREENING PAGES	SP	5/28/20
8			
9			
10			
11			

PROJECT NAME

SICILIANO

DRAWING TITLE


ELECTRICAL DETAILS


SCALE 1

AS NOTED

<u>SHEET</u>



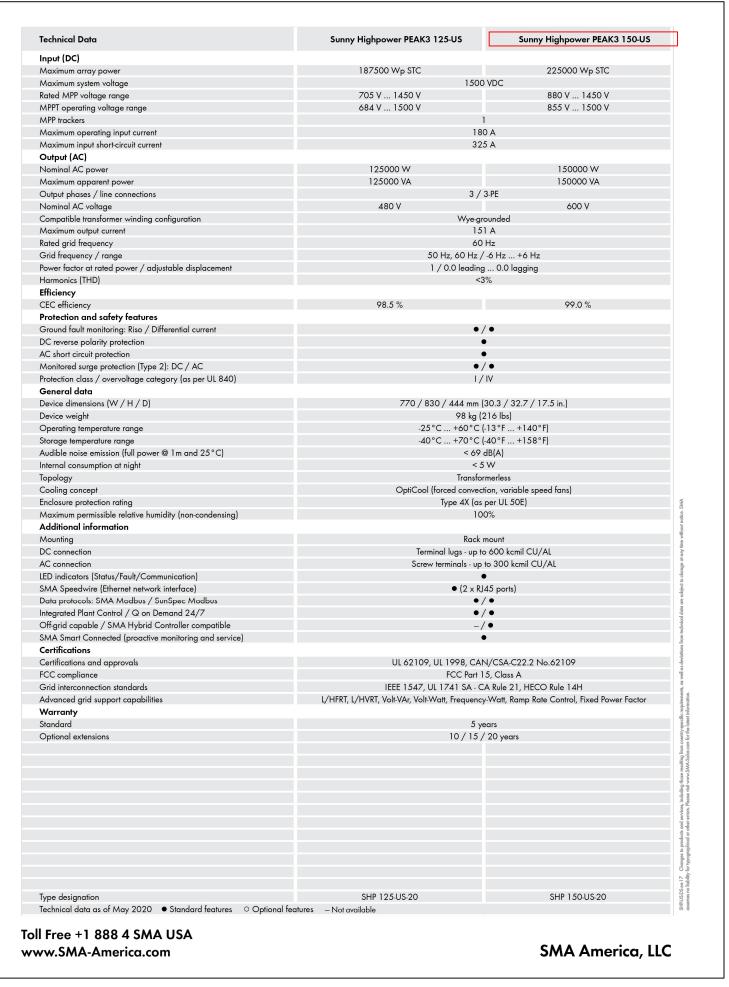

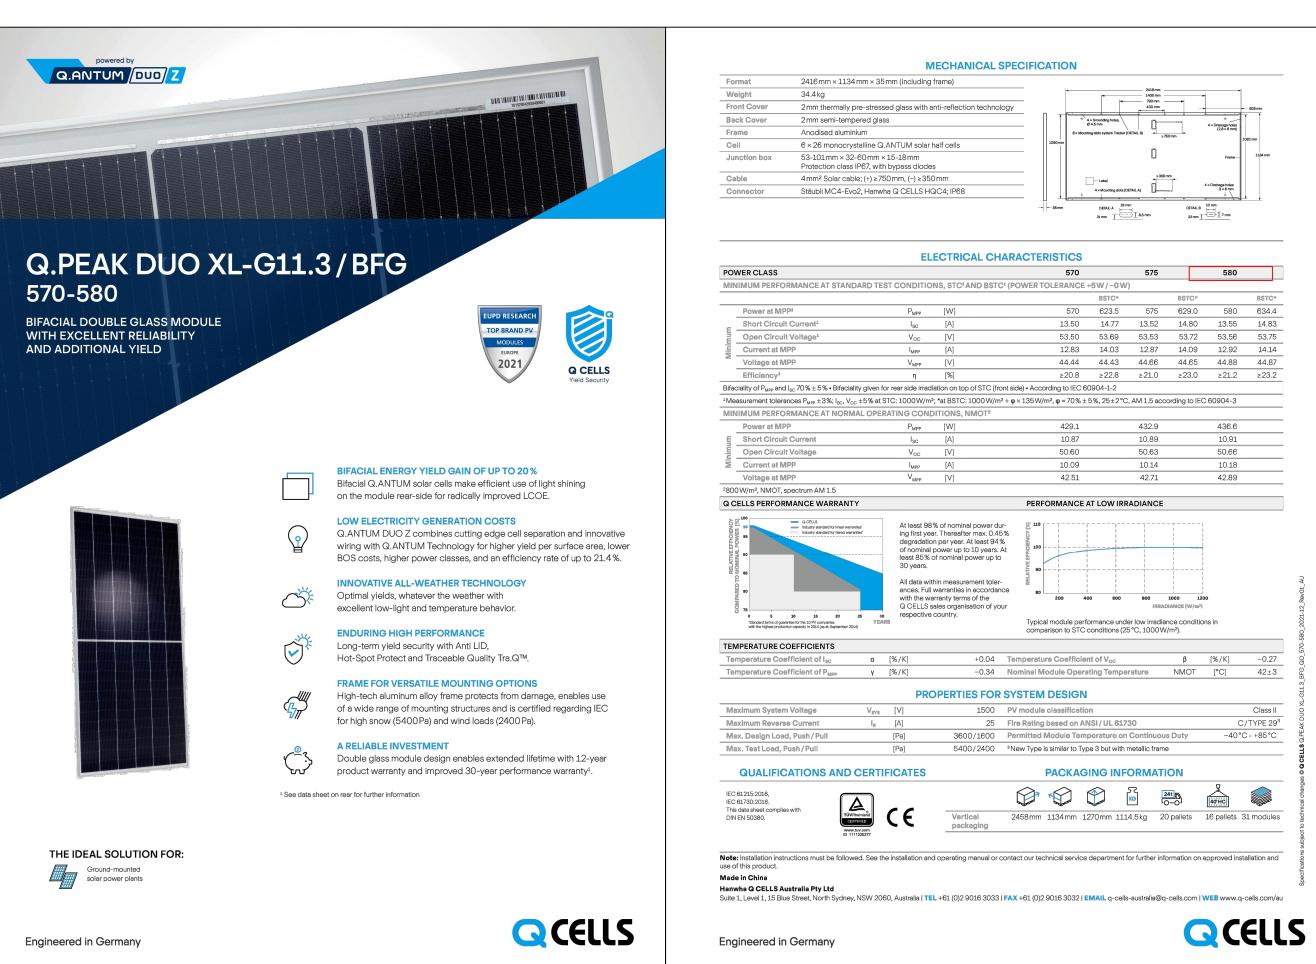



NEW ENERGY EQUITY, LLC 2530 RIVA ROAD, SUITE 200 ANNAPOLIS, MD 21041 NEWENERGYEQUITY.COM 443-267-5012

PROJECT ADDRESS 28964 S PARK AVE BEECHER, IL 60401

LAT: 41.365 LONG: -87.602

SYSTEM SPECIFICATIONS		
SYSTEM SIZE DC	7.378 MW	
SYSTEM SIZE AC	POWER LIMITED TO 5.000 MV	
DC/AC RATIO	1.476	
AZIMUTH	180°	
TILT	+/- 52°	
MODULE COUNT	12720	
MODULE TYPE	HANWHA Q.PEAK DUO XL-G11.3/BFG	
MODULE STC RATING	580 W	
INVERTER COUNT	34	
INVERTER TYPE	SMA SUNNY HIGHPOWER PEAI 150kW	
INVERTER POWER	POWER LIMITED TO 147.058 k	
RACKING	TBD	
MONITORING	ALSO ENERGY	

DESIGN CRITERIA		
MIN/MAX TEMP.	-22°C / 33°C	
WIND SPEED (ASCE 7-10)	105 MPH	
BUILDING CATEGORY	1	
EXPOSURE CATEGORY	С	
GROUND SNOW LOAD	25 PSF	
BUILDING HEIGHT	0'-0"	

OTHER NOTES
E-911 ADDRESS TO BE APPLIED FOR WITH
BUILDING PERMIT

NO POSITION, DISTANCE, OR CLEARANCE ISSUES WITH OVERHEAD ELECTRIC SERVICE LINES OR OTHER UTILITIES IN RELATION TO THE PV PANELS.

24/7 UNESCORTED KEYLESS ACCESS PROVIDED FOR ALL UTILITY ENERGY EQUIPMENT INCLUDING THE METERS AND AC DISCONNECT.

INTERCONNECTION TYPE: PRIMARY

REVISIONS			
#	DESCRIPTION	BY	DATE
0	ORIGINAL DESIGN	SP	3/20/20
1	CUP PACKAGE	SP	3/22/20
2	ACCESS RD CHANGE	SP	4/5/20
3	1.55 DC/AC RATIO CHANGE	SP	12/7/20
4	SLD WYE-DELTA WYE	SP	3/14/20
5	CUP REFRESH	SP	4/30/20
6	GAS LINE ADDITION	SP	5/9/20
7	VISUAL SCREENING PAGES	SP	5/28/20
8			
9			
10			
11			

PROJECT NAME

SICILIANO

DRAWING TITLE

EQUIPMENT DOCUMENTS 1

SCALE 1

NTS

SHEET

Ξ4



Certificate of Compliance

Certificate: 80048527

Master Contract: 254141

Project:

Hanwha Q.CELLS GmbH

17-21 Sonnenallee Thalheim Bitterfeld-Wolfen, Sachsen-Anhalt, 06766

Attention: Wiebke Engler

The products listed below are eligible to bear the CSA Mark shown with adjacent indicators 'C' and 'US' for Canada and US or with adjacent indicator 'US' for US only or without either indicator for Canada only.



Tom Yang **Issued by:** Tom Yang

PRODUCTS

CLASS - C531110 - POWER SUPPLIES Photovoltaic Modules and Panels CLASS - C531190 - POWER SUPPLIES Photovoltaic Modules and Panels - Certified to US Standards


Photovoltaic Modules with Maximum System Voltage of 1000 V dc or 1500 V dc, Class II / Application Class A, Fire Resistance Class C, Module Fire Performance Type 1, Type 2 or Type 5 (for US). Module Types: Q.PLUS L-G4.2 XXX (XXX = 305 to 375, in steps of 5W),

B.LINE PLUS L-G4.2 XXX (XXX = 305 to 375, in steps of 5W), Q.PLUS BFR-G4.1 XXX (XXX = 270 to 295, in steps of 5W and 282W), B.LINE PLUS BFR-G4.1 XXX (XXX = 270 to 295, in steps of 5W and 282W), Q.PLUS DUO L-G5.2 XXX (XXX = 340 to 385, in steps of 5W),

B.LINE PLUS DUO L-G5.2 XXX (XXX = 340 to 385, in steps of 5W),

Q.PEAK DUO L-G5 XXX (XXX = 360 to 425, in steps of 5W),

© 2022 CSA Group. All rights reserved

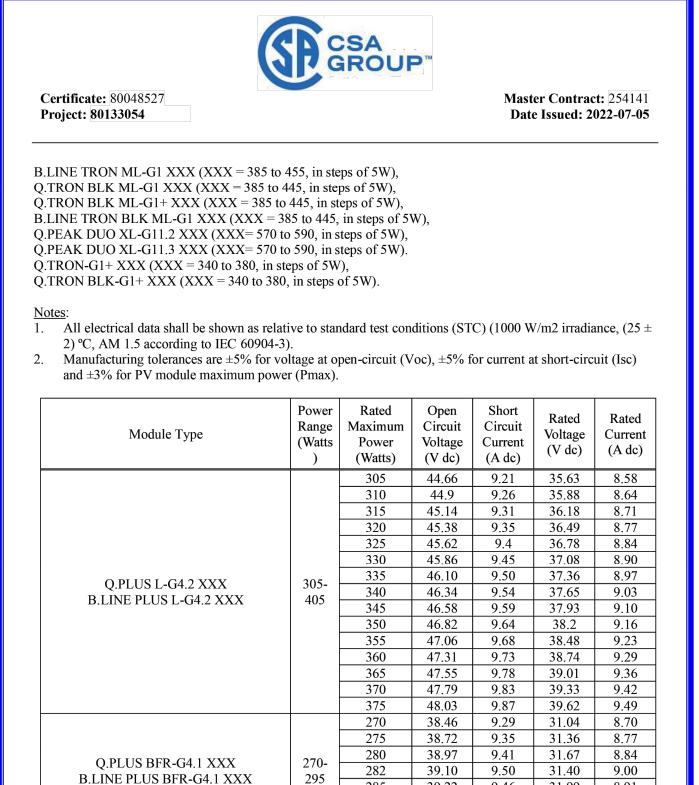



 Q.PLUS DUO L-G5.2 XXX
 340 340 340 45.89
 9.69
 37.40
 9.09


 B.LINE PLUS DUO L-G5.2 XXX
 385
 345
 46.11
 9.73
 37.68
 9.16

© 2022 CSA Group. All rights reserved.

DQD 507 Rev. 2019-04-30

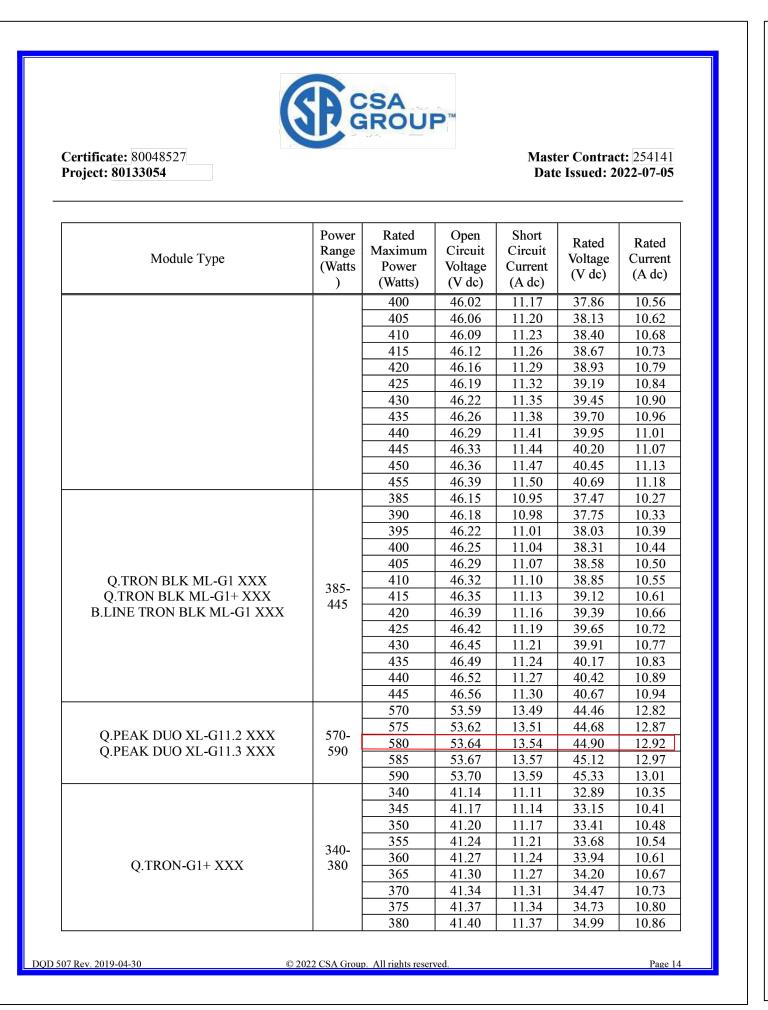

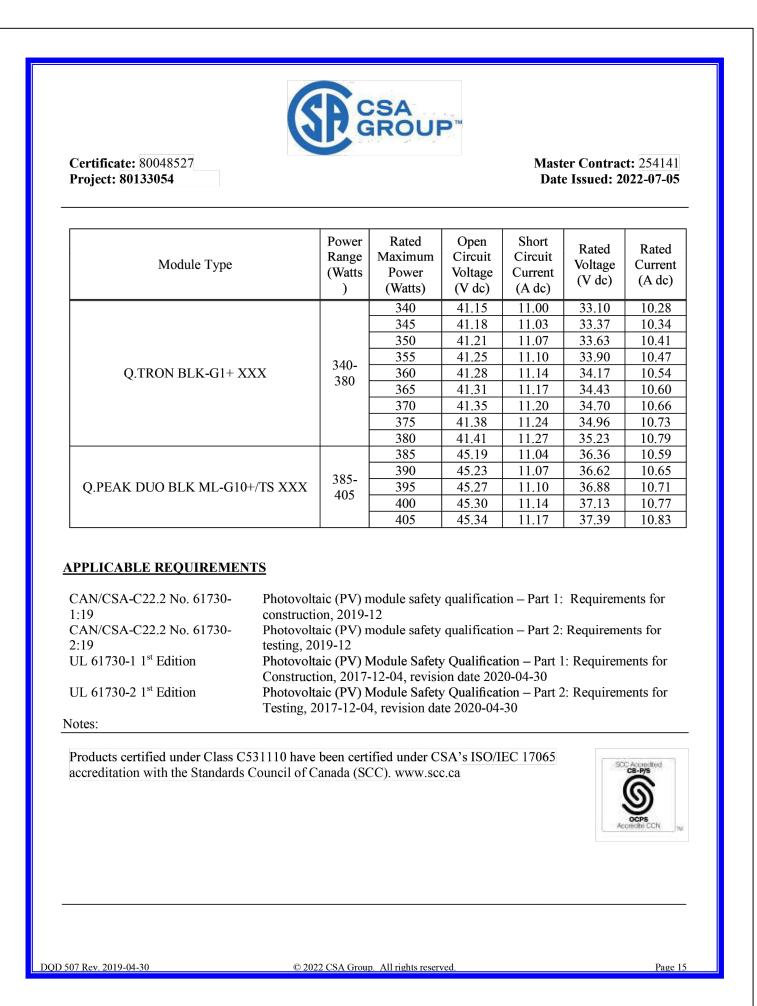

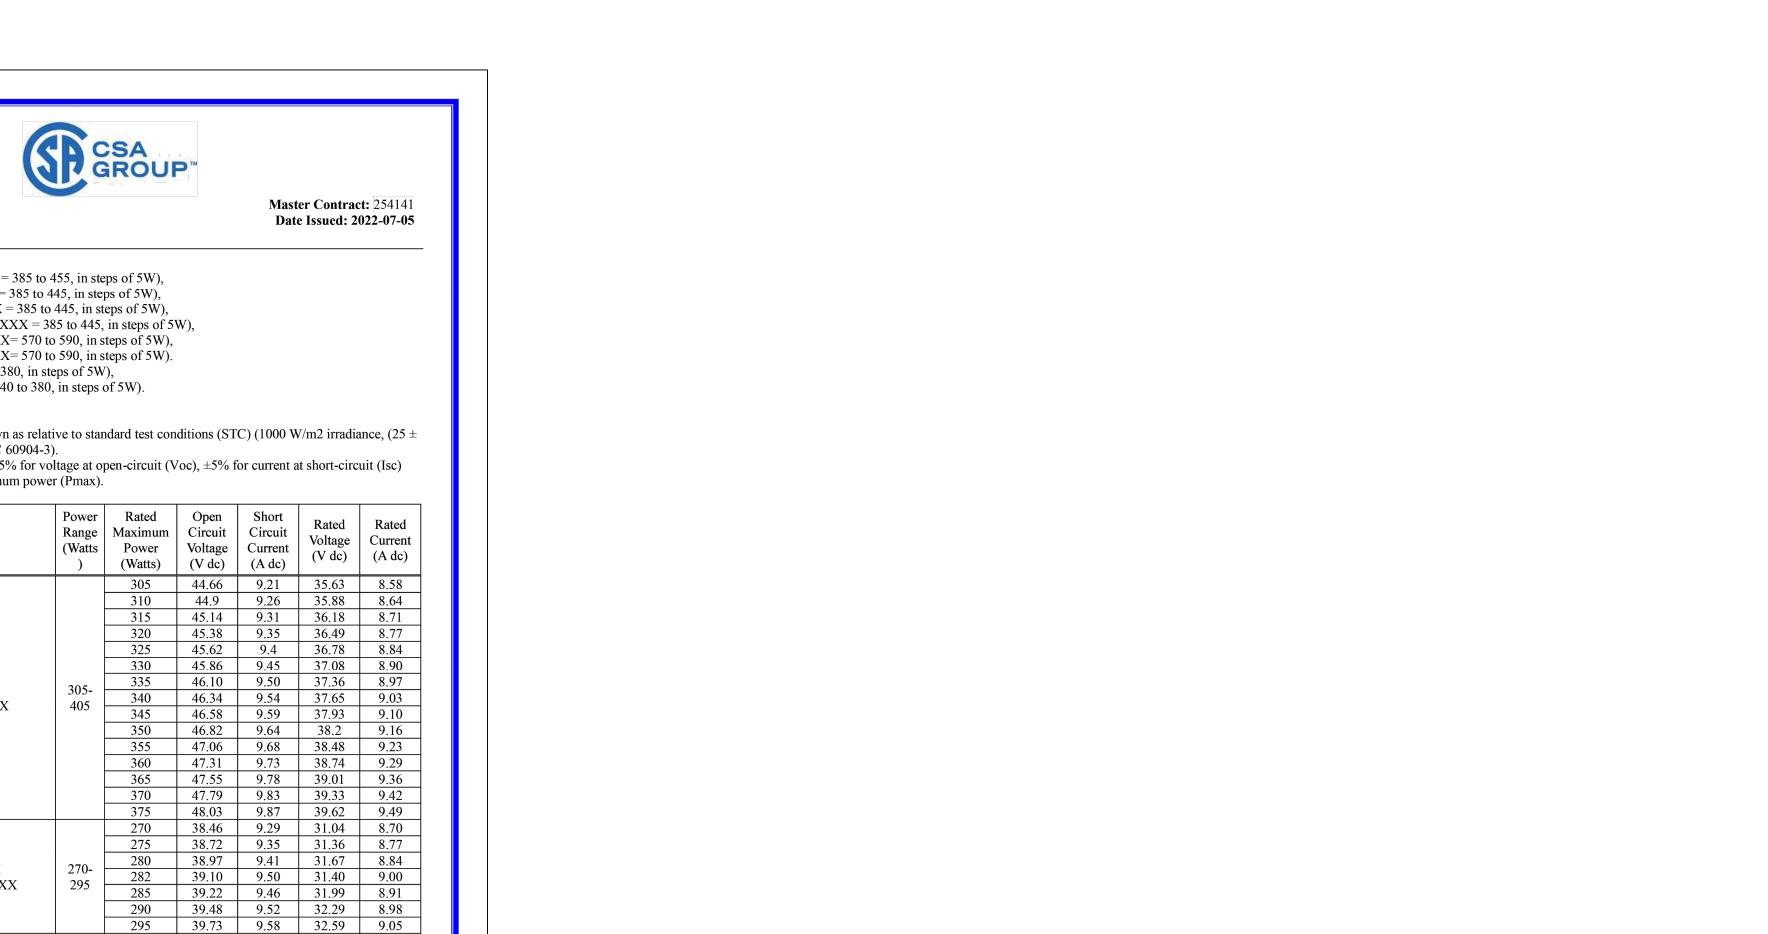

GROUND SNOW LOAD 25 PSF BUILDING HEIGHT 0'-0" OTHER NOTES E-911 ADDRESS TO BE APPLIED FOR WITH

NEW ENERGY

PROJECT ENTITY: WILD CAT SOLAR 4 LLC - SICILIANO

NEW ENERGY EQUITY, LLC 2530 RIVA ROAD, SUITE 200 ANNAPOLIS, MD 21041 NEWENERGYEQUITY.COM

443-267-5012

SYSTEM SPECIFICATIONS

SYSTEM SIZE AC POWER LIMITED TO 5.000 MW

INVERTER POWER | POWER LIMITED TO 147.058 kW

DESIGN CRITERIA

28964 S PARK AVE

BEECHER, IL 60401

SYSTEM SIZE DC

MODULE COUNT

MODULE TYPE

MODULE STC RATING

INVERTER COUNT

INVERTER TYPE

RACKING

MIN/MAX TEMP.

WIND SPEED (ASCE 7-10)

BUILDING CATEGORY

EXPOSURE CATEGORY

BUILDING PERMIT

MONITORING

DC/AC RATIO

AZIMUTH

TILT

LAT: 41.365

LONG: -87.602

180°

+/- 52°

12720

HANWHA Q.PEAK DUO

XL-G11.3/BFG

580 W

34

SMA SUNNY HIGHPOWER PEAK-3

TBD

ALSO ENERGY

-22°C / 33°C

105 MPH

NO POSITION, DISTANCE, OR CLEARANCE ISSUES WITH OVERHEAD ELECTRIC SERVICE LINES OR OTHER UTILITIES IN RELATION TO THE PV PANELS.

24/7 UNESCORTED KEYLESS ACCESS PROVIDED FOR ALL UTILITY ENERGY EQUIPMENT INCLUDING THE METERS AND AC DISCONNECT.

INTERCONNECTION TYPE: PRIMARY

REVISIONS					
#	DESCRIPTION	BY	DATE		
0	ORIGINAL DESIGN	SP	3/20/20		
1	CUP PACKAGE	SP	3/22/20		
2	ACCESS RD CHANGE	SP	4/5/20		
3	1.55 DC/AC RATIO CHANGE	SP	12/7/20		
4	SLD WYE-DELTA WYE	SP	3/14/20		
5	CUP REFRESH	SP	4/30/20		
6	GAS LINE ADDITION	SP	5/9/20		
7	VISUAL SCREENING PAGES	SP	5/28/20		
8					
9					
10					
11					

PROJECT NAME SICILIANO

DRAWING TITLE

EQUIPMENT DOCUMENTS 2

SCALE 1

SPACE FOR PE STAMP:

SHEET

CERTIFICATE OF COMPLIANCE

Certificate Number 20190417-E210376 Report Reference E210376-20190328 Issue Date 2019-APRIL-17

> Issued to: SMA Solar Technology AG Sonnenallee 1 34266 Niestetal GERMANY

representative samples of

This certificate confirms that STATIC INVERTERS, CONVERTERS AND ACCESSORIES FOR USE IN INDEPENDENT POWER

SYSTEMS

Permanently-connected, utility Interactive, 3-phase inverter, Models: SHP 150-US-20, SHP 125-US-20. (which are intended for DC input from photovoltaic modules)

Have been investigated by UL in accordance with the Standard(s) indicated on this Certificate.

Standard(s) for Safety: Please see addendum page

Additional Information: See the UL Online Certifications Directory at https://iq.ulprospector.com for additional information.

This Certificate of Compliance does not provide authorization to apply the UL Mark. Only the UL Follow-Up Services Procedure provides authorization to apply the UL Mark.

Only those products bearing the UL Mark should be considered as being UL Certified and covered under UL's Follow-Up Services.

Look for the UL Certification Mark on the product.

Any information and documentation involving UL Mark services are provided on behalf of UL LLC (UL) or any authorized licensee of UL. For questions, please contact a local UL Customer Service Representative at http://ul.com/aboutul/locations/

CERTIFICATE OF COMPLIANCE

Certificate Number 20190417-E210376 Report Reference E210376-20190328 Issue Date 2019-APRIL-17

This is to certify that representative samples of the product as specified on this certificate were tested according to the current UL requirements.

Standard(s) for Safety:

UL 62109-1, Safety of power converters for use in photovoltaic power systems – Part 1: General

CSA C22.2 No. 62109-1 Safety of power converters for use in photovoltaic power systems - Part 1:

General requirements. CSA C22.2 No. 62109-2 Safety of power converters for use in photovoltaic power systems - Part 2:

Particular requirements for inverters.

Any information and documentation involving UL Mark services are provided on behalf of UL LLC (UL) or any authorized licensee of UL. For questions, please contact a local UL Customer Service Representative at http://ul.com/aboutul/locations/



PROJECT ENTITY: WILD CAT SOLAR 4 LLC - SICILIANO

NEW ENERGY EQUITY, LLC 2530 RIVA ROAD, SUITE 200 ANNAPOLIS, MD 21041 NEWENERGYEQUITY.COM 443-267-5012

PROJECT ADDRESS 28964 S PARK AVE BEECHER, IL 60401

LAT: 41.365 LONG: -87.602

SYSTEM	SPECIFICATIONS	
SYSTEM SIZE DC	7.378 MW	
SYSTEM SIZE AC	POWER LIMITED TO 5.000 MW	
DC/AC RATIO	1.476	
AZIMUTH	180°	
TILT	+/- 52°	
MODULE COUNT	12720	
MODULE TYPE	HANWHA Q.PEAK DUO XL-G11.3/BFG	
MODULE STC RATING	580 W	
INVERTER COUNT	34	
INVERTER TYPE	SMA SUNNY HIGHPOWER PEAK-3 150kW	
INVERTER POWER	POWER LIMITED TO 147.058 kW	
RACKING	TBD	
MONITORING	ALSO ENERGY	

DESIGN CRITERIA				
MIN/MAX TEMP.	-22°C / 33°C			
WIND SPEED (ASCE 7-10)	105 MPH			
BUILDING CATEGORY	I			
EXPOSURE CATEGORY	С			
GROUND SNOW LOAD	25 PSF			
BUILDING HEIGHT	0'-0"			

OTHER NOTES E-911 ADDRESS TO BE APPLIED FOR WITH BUILDING PERMIT

NO POSITION, DISTANCE, OR CLEARANCE ISSUES WITH OVERHEAD ELECTRIC SERVICE LINES OR OTHER UTILITIES IN RELATION TO THE PV PANELS.

24/7 UNESCORTED KEYLESS ACCESS PROVIDED FOR ALL UTILITY ENERGY EQUIPMENT INCLUDING THE METERS AND AC DISCONNECT.

INTERCONNECTION TYPE: PRIMARY

REVISIONS				
#	DESCRIPTION	BY	DATE	
0	ORIGINAL DESIGN	SP	3/20/20	
1	CUP PACKAGE	SP	3/22/20	
2	ACCESS RD CHANGE	SP	4/5/20	
3	1.55 DC/AC RATIO CHANGE	SP	12/7/20	
4	SLD WYE-DELTA WYE	SP	3/14/20	
5	CUP REFRESH	SP	4/30/20	
6	GAS LINE ADDITION	SP	5/9/202	
7	VISUAL SCREENING PAGES	SP	5/28/20	
8				
9				
10				
11				

PROJECT NAME

SICILIANO

DRAWING TITLE

EQUIPMENT DOCUMENTS 3

SCALE 1

SHEET

SPACE FOR PE STAMP:



30200 Town Center Rd Beecher, IL 60401

Supervisor Michael Stanula

Assessor Pat Peters

Highway CommissionerMichael Smith

ClerkJoe Burgess

Trustees
Tracy Heldt
Teresa Peterson
George Obrdavich
Mark Herlitz

August 16, 2024

Beecher Plan Commission

Solar Garden

Re: Proposed Development – Wild Cat Solar 4 LLC, Siciliano Community

Dear Commissioners

The following letter shall address the Washington Township Board of Trustees' concerns regarding the zoning case.

We do not recommend the Zoning request nor the Special Use Variances for a Solar Farm. We are familiar with so called "Solar Farms". They continue to scar the landscape, replacing farmland which benefit our residents both regionally as well as nationally. Solar Farms benefit a select few and provide large profits to the developers. The long-term effects of solar farms have yet to be seen. The present effects we do know include migratory bird and wildlife disruption, loss of crop land and un-natural soil warming. Many components of the solar panels are also not recyclable once the life cycle of the equipment has ended. The longevity of the start-up solar developers to provide long term service and restoration of the property back to original ground is yet to be seen.

Solar Farm developers believe that if they put their projects out in the country no one will notice. We as a township do indeed notice, however we have our hands tied, due to state legislation, which limits our control over wind and solar energy projects, the best that we can do is to state our point of view and make recommendations.

The Siciliano Community Solar Garden (it's not a garden) project as proposed is to be in Beechers' backyard. Hopefully the residents of Nantucket Cove will notice.

I have attached the last two correspondence letters sent to Will County Planning expressing our concerns over recent solar projects. Once a case number has been assigned to this project, I will do the same.

Michael Stanula- Washington Township Supervisor


Cc: Village of Beecher Board of Trustees

Judy Ogalla, Chairman of the Will County Board

SURFInternet

Lighting Up Communities!

Who is Surf Internet?

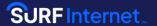



Surf Internet:

- Three decades of innovation, connecting people to what they love, and providing broadband connectivity
- Registered utility and ISP
- Over 200 employees in three states
- Among the Largest providers of broadband to schools
- Over 100,000 passings
- In 100+ communities
- Funded with mix of corporate, private equity and grants

Our Greatlakes Footprint




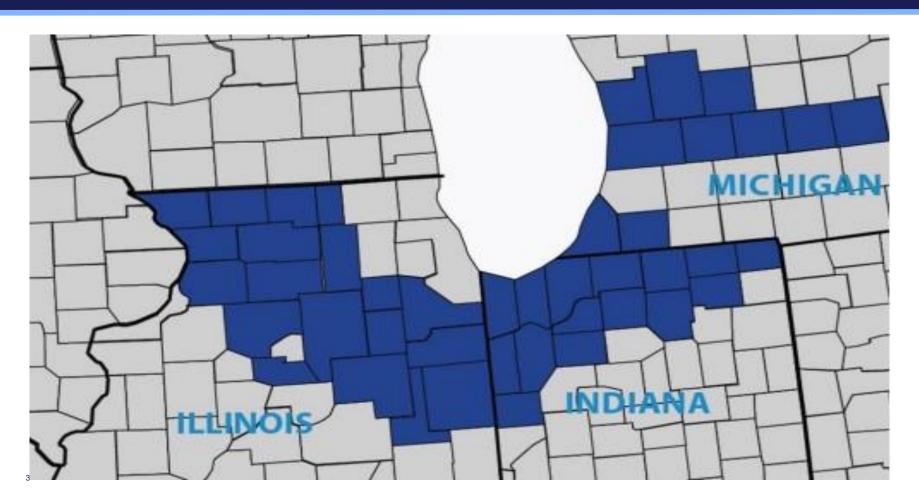

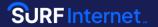


Surf Internet Core Values

- Reliability people, network, customers
- Integrity culture, management, partners, suppliers
- Innovation revolutionary, creative, transformative
- Illumination LIGHTING UP COMMUNITIES

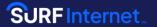

Surf Internet Mission


 To transform the future of communities with high-speed reliable connectivity. We believe when this is made possible it becomes the great equalizer.

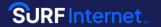

Why Fiber?


- Speed and Bandwidth
- Unlimited Capacity
- Symmetrical Speeds
- Number of Devices / Future Innovation

Pre Construction Topics

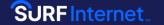

- Review the initial build plan / high level plans
- Construction: buried vs aerial
- Guidance from city on footprint and the process to get started
- Locates: sewer, water, gas, electric
- Permit Process
- Potential Construction Start Date
- Resident pre-construction notification process
- Construction process overview

Getting Started Discussion Topics

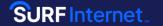

- **Buried vs Aerial Construction**
 - ROW, right of way, or Utility Easement Is there any rear easement?
- **Buried Construction**

 - Permitting Process
 Make Ready Process: Comms & Power

Locates and Permitting

- Locates:
 - Sewer
 - Water
 - Gas
 - Electric
- **Permit Process:**
 - What type of permits does the city require General communication with the city

OLT and Construction Yard



Walkout & Design

- Surf will walkout the town to assist in design
- Low level design will be completed
- Needs to consider in the design

Active Cabinet (Electronics Cabinet Placement)

- Normally place within the Right of Way
- We notify the city of our recommended placement
- Suggestions from the city are always welcome

Construction Yard:

Does the city have a location we can use to store material during the construction process



Resident Pre-construction Notification Process



Construction Notification Letter



SAMPLE COMPANY 129 WEST 81ST STREET APT 5A NEW YORK, NY 10024



MONTGOMERY ANTETOKOUNMPO UNITED STATES POSTAL SERVICE 129 WEST 81ST STREET APARTMENT 5A NEW YORK, NY 10001

- Ուկրոլկել Ունոեվ իկ իկիկ իրկելով իլի հեռենի իլի

Dear Resident,

We're excited to announce that Surf fiber internet is coming to your neighborhood. With **speeds up to 1 Gig**, you'll soon enjoy a fast, reliable internet connection for work, school and everyday life.

The construction phase will commence soon, and we're committed to making it a smooth process. Here is a general guideline of what you can expect:

- First, we'll secure all city and local permits required. Once this happens we'll call out 811 Locates to mark (flag) all underground utilities to avoid disruption.
- Next, our Surf authorized contractors will create a path for our network and will set up a connection point in the utility easement of your property. Equipment may be temporarily positioned on your lawn.
- Once immediate underground construction in front of your home is completed, any temporary holes and pathways will be filled-in promptly.
- Within a few weeks a crew will arrive to finalize the restoration of your yard, which may include seeding and laying straw where bare spots were created on the lawn, smoothing out ruts and dents, etc.
- After construction is completed for the entire neighborhood, Surf will conduct a final walkthrough to compile a detailed list of any remaining issues to be addressed, which would include bare spots where the initial seeding was unsuccessful.

Rest assured it is Surf's priority to leave your property in a satisfactory state and be a thoughtful neighborl To learn more about our construction and yard restoration processes or to submit any questions, concerns, or issues, visit Surfinternet.com/construction. To speak with one of our local customer care team members please call (844) 445-SURF.

We look forward to being a part of your community!

With appreciation,

Gene Crusie Chief Executive Officer Surf Internet

Learn more about Surf fiber internet and to get pricing for your area at Surfinternet.com or call (844) 445-SURF.

Once we are notified that construction will begin in approximately 2-weeks, Surf triggers notifications to be sent to residents along with signage to be placed at and around the area.

Letters are sent to all residential addresses within a project area. It takes approximately 10 days for the letter to process and be delivered.

The letter has three main functions:

- 1. To inform residents that construction will begin in their neighborhood soon.
- 2. To explain what to expect during the construction process.
- To provide information on how to sign up for notifications and how to contact Surf with questions or concerns.

Construction Notification Email



Along with the letter, an email notification is also sent out in the automated workflow to any residents for whom we may already have an existing email address.

Email notifications will be received the same day they are sent.

The email is a pared-down version of the construction letter and is intended to be an additional touch-point in case someone misses the notification letter.



FIBER IS COMING!

Hello Neighbor,

We're excited to announce that Surf Internet, with **speeds up to 1 Gig**, is coming to your neighborhood. You'll soon enjoy a fast, reliable internet connection for work, school, and everyday life.


Rest assured, we're committed to making the construction phase a smooth process as our Surf-authorized contractors build out your neighborhood. We have a variety of resources that can provide more information on the process and give you an idea of what to expect as we pass through.

Learn more about Surf Internet.



Learn more about our construction and yard restoration processes, find valuable FAQs, and get project statuses.

Construction Signs - 36" x 24" Intersection signs

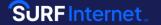

Along with triggering notification letters and emails, construction signs will also be deployed throughout the project area. There are two types of construction signs placed in the neighborhood.

The first type is a 36"x24" sign placed at various intersections. Typically they are placed at intersections per approximately every 10 homes.





Questions? Call: 1-844-445-SURF Visit: SurfInternet.com/Construction



Construction Vehicles and Reels









SURF Internet

Questions? Call: 1-844-445-SURF Visit: SurfInternet.com/Construction

Additional Signage is placed in contractor vehicles and both the conduit and fiber reels.





Authorized Contractor


888-274-6381


SurfInternet.com

Construction Process Overview and Customer Installation Experience



Underground: Directional Drilling

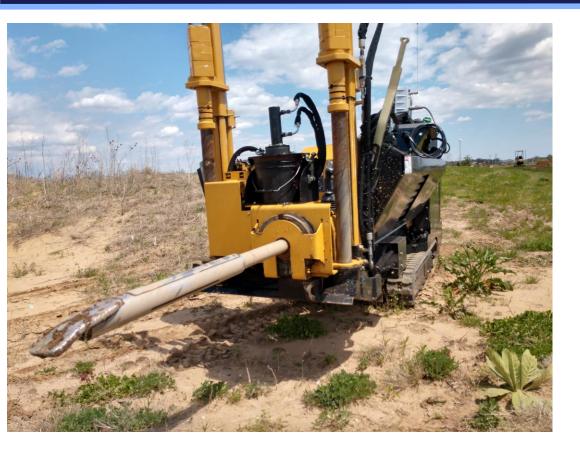

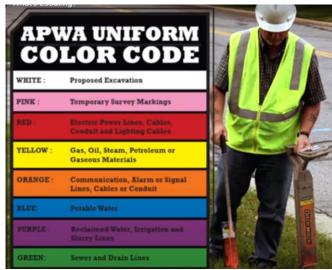



Placing Conduit







Pulling fiber into the conduit









Handholes that will be in residents yards & Install Process

Handhole in yard



Running the fiber drop to the house



Accessing the fiber to service the customer




Burying the drop- Final state





Surf Internet Fiber to the Home Pricing

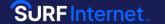

SURF 100

Reliable speed for standard activities like streaming and social media.

- 100 Mbps symmetrical upload & download speeds
- Free Whole-Home WiFi powered by eero™ (1 device included)
- No contracts
- Free expert installation
- Price-Lock for Life

SURF 500

Consistent, fast speed ideal for multi-device users, video conferencing, or multi-player gaming.

- 500 Mbps symmetrical upload & download speeds
- Free Whole-Home WiFi powered by eero™ (1 device included)
- No contracts
- Free expert installation
- Price-Lock for Life

SURF 1 GIG


Serious Surfing

Ideal for heavy users on multiple devices, 4K streaming, garning and VR.

- 1 Gbps symmetrical upload & download speeds
- Free Whole-Home WiFi powered by eero™ (2 devices included)
- No contracts
- Free expert installation
- Price-Lock for Life

No Contracts / Price Lock for Life / No Connection Fee / No Additional Fees or Taxes

Additional Topics

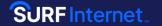

Additional Topics and Questions:

- Upcoming planned improvements
- Door to door
- Construction times / Ordinances
- Road cutting / boring
- Utility newsletter / communicating to residents
- Social Media
- Community Engagement
- Groundbreaking / Ribbon Cutting
- Project Kick Off / Tailgate Meetings

Next Steps



What next?

- Council / Public Meeting
- Walkout
- Detailed Plans
- Start Permit Process
- Share files and contacts

SURFInternet

Thank you!